: R#1.009548 4-22-15

Print Form



City of Fitchburg
Planning/zoning Department
5520 Lacy Road
FITCHBURG
Fitchburg, Wi 53711 (608-270-4200)

REZONING APPLICATION

district map of the Fitchburg zoning ordinance by reclassifying from the GIP district to the SIP district the
following described property:
1. Location of Property / Street Address: Northeast Corner of Fitchrona Rd. & Lacy Rd.
Legal Description - (Metes & Bounds, or Lot No. And Plat):
Part of Lots 1, 2 and 3, Certified Survey Map No. 11159 recorded in Volume 67 of Certified Survey Maps on pages 152–154 as Document Number 3959694, Dane County Registry, located in the NW1/4 of the NW1/4 of Section 18, T6N, 9E, City of Fitchburg, Dane County, Wisconsin. See attached PDD-SIP submittal.
***Also submit in electronic format (MS WORD or plain text) by email to: planning@city.fitchburg.wi.us
2. Proposed Use of Property - Explanation of Request:
Apartment Homes (Multi-Family Residential)
B. Proposed Development Schedule: See attached PDD-SIP Submittal
I. Future Land Use Plan Classification: High Density Residential (HDR)
*Pursuant to Section 22-3(b) of the Fitchburg Zoning Ordinance, all Rezonings shall be consistent with the currently dopted City of Fitchburg Comprehensive Plan.
**Attach three (3) copies of a site plan which shows any proposed land divisions, plus vehicular access points and the ocation and size of all existing and proposed structures and parking areas. Two (2) of the three (3) copies shall be no arger than 11" x 17". Submit one (1) electronic pdf document of the entire submittal to planning@city.fitchburg.wi.us . Additional information may be requested.
ype of Residential Development (If Applicable): Apartement Homes (Multi-Family Residential)
otal Dwelling Units Proposed: 152 No. Of Parking Stalls: 238 total
ype of Non-residential Development (If Applicable): n/a
Proposed Hours of Operation: No. Of Employees:
loor Area: No. Of Parking Stalls:
Sewer: Municipal Private X Water: Municipal Private X
Current Owner of Property:
Address: Phone No:
Contact Person: Craig Raddatz, Fiduciary Real Estate Development, Inc.
mail: craddatz@fred-inc.com
Address: 789 N. Water St Suite 200, Milwaukee, WI 53202 Phone No: 414-226-4535
Respectfully Submitted By: Craia Raddat ?
Owner's or Authorized Agent's Signature Print Owner's or Authorized Agent's Name
LEASE NOTE - Applicants shall be responsible for legal or outside consultant costs incurred by the City. Submissions shall be made at least four (4) weeks prior to desired plan commission meeting.
or City Use Only: Date Received: 4 21 2015 Publish: and
ordinance Section No Fee Paid: \$825.00
ermit Request No. 27-2057-15

Susan Badtke

From:

Keith Hammersley <keith@hammersleystone.com>

Sent:

Monday, April 20, 2015 11:45 AM

To:

Susan Badtke

Subject:

Authorization for Fiduciary to submit Rezoning request

Hamm Fam land LLC authorizes Fiduciary to submit rezoning request for pdd sip zoning on proposed lot 15 Quarry Vista plat

Thank you,

Keith Hammersley Hamm Fam Land Ilc

Keith Hammersley President

Hammersley Stone Co., Inc. 6291 Lacy Road Fitchburg, WI 53593

608.845.7804



ELAN APARTMENT FITCHBURG, WISCONSIN

Fiduciary REAL ESTATE DEVELOPMENT, INC



SPECIFIC IMPLEMENTATION PLAN - AMENDED

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 - SIP Architectural Plans
- APPENDIX 'D' Sign Program
- APPENDIX 'E' Neighborhood Input Information

PROJECT TEAM:



FIDUCIARY REAL ESTATE DEVELOPMENT, INC

789 North Water Street - Suite 200 Milwaukee, Wisconsin 53202 Contact: Craig Raddatz 414.226.4535



D'ONOFRIO, KOTTKE, & ASSOCIATES, INC.

7530 Westward Way

Madison, Wisconsin 53717

Contact: Bruce J. Hollar

608.833.7530

PREVIOUS GENERAL IMPLEMENTATION PLANS

THIS DOCUMENT SHALL SERVE AS THE SPECIFIC IMPLEMENTATION PLAN TO THE PREVIOUS GENERAL DEVELOPMENT PLANS:

• THE QUARRY VISTA APARTMENT HOMES GENERAL IMPLEMENTATION PLAN DATED OCTOBER 21, 2014, AMENDED NOVEMBER 5, 2014, AND APPROVED BY THE FITCHBURG COMMON COUNCIL ON NOVEMBER 25, 2014.

IN ADDITION, THIS DOCUMENT SHALL SERVE AS AN AMENDMENT TO THE SPECIFIC IMPLEMENTATION PLAN DATED APRIL 21, 2015.

THE SUBSTANTIVE & REGULATING TEXT OF THIS SPECIFIC IMPLEMENTATION DOCUMENT IS EXACTLY AS IT APPEARS IN THE GENERAL IMPLEMENTATION PLAN AMENDMENT DATED NOVEMBER 5, 2014. THE DIFFERENCES BETWEEN THIS DOCUMENT AND THE SPECIFIC IMPLEMENTATION PLAN DATED APRIL 21, 2015 ARE HIGHLIGHTED IN YELLOW.

ADDITIONAL INFORMATION SUCH AS MORE DETAILED CIVIL ENGINEERING PLANS, ARCHITECTURAL PLANS, AND LANDSCPAE PLANS ARE CONTAINED IN APPENDIX 'C' OF THIS DOCUMENT.



JLA ARCHITECTS + PLANNERS

2418 Crossroads Drive - Suite 2300 Madison, Wisconsin 53718

Contact: Joseph Lee 608.241.9500

PROJECT LOCATION & GENERAL DESCRIPTION

The Elan Residential Development will be a quality high-density residential community to serve the increased demand for housing in the Fitchburg area over the next five years and beyond. It will be located on a 4.84 acre site at the north east corner of the current intersection of Fitchrona Road and Lacy Road.

• Outlot 9 / Proposed Lot 15 - The 4.84 acre parcel for residential uses of this project.

Surrounding Context

The project site is surrounded by existing residential uses to the immediate north, south, and west with recreational uses further northeast (Quarry Ridge Recreation Area), light industrial uses further north (north of Verona Rd.), and future single family residential use to the immediate east.

Existing Topography & Wetlands

The project site has moderate topographical relief - with about 20 feet of grade drop from the southeast portion of the site to the north and west portion of the site. The northwest portion of the site is the low point of the site.

Existing Vegetation

The project site is adjacent to an existing quarry. The northern and eastern portion of the site currently contains the majority of the site's vegetation – with various trees and underbrush. There are no known landmark or heritage trees on the property. The Quarry Vista developer is delivering a cleared and graded site.




<u>Legal Description – Outlot 9 / Proposed Lot 15 of Quarry Vista</u> <u>Preliminary Plat (Entire Property)</u>

Part of Lots 1, 2 and 3, Certified Survey Map No. 11159 recorded in Volume 67 of Certified Survey Maps on pages 152-154 as Document Number 3959694, Dane County Registry, located in the NW1/4 of the NW1/4 of Section 18, T6N, 9E, City of Fitchburg, Dane County, Wisconsin to-wit:

Commencing at the Northwest corner of said Section 18; thence \$89°50'48"E, 70.73 feet along the North line of said NW1/4; thence \$02°09'12"W, 34.25 feet to a point of curve also being the point of beginning; thence Easterly along a curve to the right which has a radius of 30.00 feet and a chord which bears N81°49'03"E. 10.77 feet; thence \$87°50'32"E, 257.45 feet to a point of curve; thence Easterly along a curve to the left which has a radius of 478.00 feet and a chord which bears N85°53'55.5"E, 104.23 feet to a point of curve; thence Southeasterly along a curve to the right which has a radius of 15.00 feet and a chord which bears \$53°05'23"E, 22.04 feet; thence \$05°49'08"E, 447.90 feet; thence \$77°20'54"W, 140.54 feet; thence \$77°15'15"W, 205.69 feet to a point of curve; thence Southwesterly along a curve to the right which has a radius of 356.24 feet and a chord which bears \$83°37'38"W, 79.08 feet; thence N90°00'00"W, 27.59 feet; thence N00°56'55"E, 544.54 feet to the point of beginning.

Containing 210,871 square feet (4.841 acres).

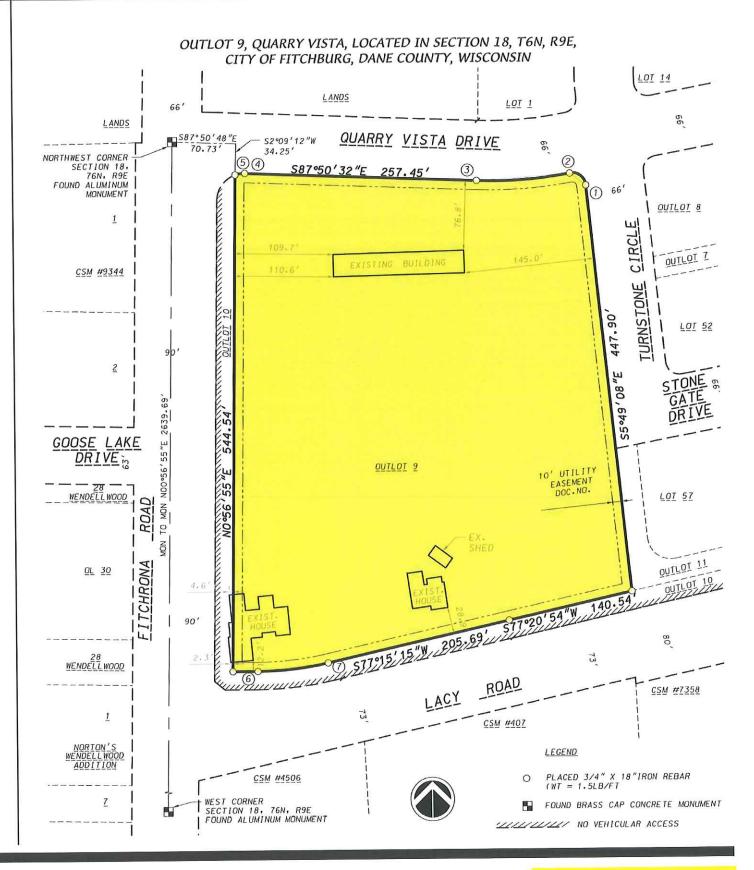

RATIONALE FOR A PLANNED DEVELOPMENT DISTRICT

As confirmed by the City Plan Commission at their September 16, 2014 meeting, in which they expressed a "preference for the applicant to use PDD zoning for this project", this project will utilize the City's PD Planned Development District instead of the City's R-H High Density District.

Specifically, in order to accomplish the goals of providing a quality highdensity infill development with first class amenities, we reference the City's Ordinance with the following reasons:

- <u>Section 22-144 Permitted Uses (3):</u> Only permits up to 8 units per building. While we realize dwelling structures having greater than eight dwelling units are allowed as a Conditional Use (per 22-145 (6)), we desire the long-term stability afforded under a permanent zoning classification.
- <u>Section 22-146 Dimensional Standards (1):</u> Does not allow more than two multiple family dwelling unit structures per lot. We are proposing three multiple family dwelling unit structures on one lot. To make this an integrated, vibrant community, we must have the design flexibility afforded in the PD zoning for the drives, parking lots, and walking connections between buildings.
- <u>Section 22-146 Dimensional Standards (2) b</u>: Requires a minimum of 2,000 square feet of lot area per each Efficiency unit, 2,200 square feet of lot area per each 1 bedroom unit, and 2,400 square feet per each 2 bedroom unit, with the provision that each structured parking space reduces the minimum lot area by 500 square feet. We are proposing 10 Efficiencies, 88 One Bedrooms,

and 54 Two Bedrooms and 149 structured parking spaces. This provision would require our proposed lot to be 6.25 acres, based on our proposed 152 units. The City has already approved the lot (via approval of the final plat of Quarry Vista) at 4.84 acres and the maximum units of 156.

- <u>Section 22-146 Dimensional Standards (2) c:</u> Restricts lot size to a maximum of 90,000 square feet. We are purchasing one developable lot for this project, already approved by the City, with an area of 210,871 square feet or 4.84 acres.
- <u>Section 22-146 Dimensional Standards (4)</u>: Sets the minimum front setback at 30 feet. In keeping with the City's desire to provide a more urban feel to multi-family residential developments, we propose a minimum 10 foot setback.
- <u>Section 22-146 Dimensional Standards (6)</u>: Sets the minimum street side setback at 25 feet. In keeping with the City's desire to provide a more urban feel to multi-family residential developments, we propose a minimum 10 foot setback.
- <u>Section 22-146 Dimensional Standards (8):</u> Restricts the maximum building height to 45 feet. We are planning 3-stories of residential over an underground parking structure for each building. Although we have not yet developed the architectural building elevation, given the site topography and the need to work with the land, the maximum building height will likely be exceeded.

ECONOMIC & SOCIAL IMPACTS

We believe that this project will have positive economic & social impacts on the area.

Property Values and Tax Revenue

At total completion, it is estimated that this project would have a total value of approximately \$20,520,000. At this value, using the City's 2013 property tax rate the following tax receipts to the community could be realized annually:

State of Wisconsin:	\$3,500
Dane County:	\$64,000
City of Fitchburg:	\$161,000
Verona School District:	\$217,000
Madison Area Tech. College:	\$38,000
Total Projected Annual Property Tax:	\$483,500

In addition to the value of this specific project, the surrounding properties could realize an increase in values because of this project - thus creating additional tax revenues.

Impact Fees

This project should generate the following estimated Impact Fees to the City (2015 fees listed):

Total Projected Impact Fo		\$186,816
Water Impact Fee:	152 units x \$691 =	\$105,032
	54 2BR x \$473 =	\$25,542
Fire Protection Fee	98 ST/1BR x \$349 =	\$34,202
Park Improvement Fee	152 units x \$145 =	\$22,040

Social Impacts

Although social impacts cannot be predicted or quantified, we believe that this project will also have a positive social impact on the area.

- The addition of this quality residential community should improve the perceived image of the immediate area.
- The addition of this quality residential community will help to keep existing residents in Fitchburg and bring new residents into Fitchburg.
- The addition of this quality residential community could serve as a catalyst for other uses such as retail & commercial to locate in the immediate area.
- The addition of this quality residential community could serve as an example for future development creating higher standards in design & quality.

CONSISTENCY WITH COMPREHENSIVE PLAN

This project complies with the City of Fitchburg's Comprehensive Plan.

Specifically, the following is an analysis of how this project meets or advances the goals, objectives, and policies outlined in the Comprehensive Plan.

Land Use Goal 1:

This project preserves and enhances the natural features of the City as follows:

Objective 1: This project is consistent with the long term urban growth map and related phasing plan.

Policies:

- (2) This project will be served by gravity flow sanitary sewer
- (3) This project is being developed in the urban growth boundary and is not replacing high quality agricultural lands.
- (5) This project (growth) is consistent with the neighborhood

plan

Objective 2: This project is protecting environmental resources by using high density, sustainable development and revitalization of underutilized land.

Policies:

- (2) This project is not within or near identified wetlands
- (7) This project is not within or near identified floodplains

Land Use Goal 2:

This project is a compact urban community that is visually and functionally distinct from the rural and agricultural community.

Objective 1: This is a project that is a significant reinvestment in the community as a redevelopment of underutilized land.

Policies:

(1) This is a redevelopment of a former gravel pit.

Objective 3:

This is a compact development that, when incorporated into the entire Quarry Vista development, will have a logical and sustainable mix of uses and building types.

Policies:

(1) This project provides needed residential rental units.

(2) This project fits in well with the existing and planned

infrastructure and land uses.

Objective 5:

Utilities and infrastructure are being extended to this project in an efficient manner.

Policies:

(1) This project is within the urban growth area.

(3) This high-density project makes use of the location near Fitchrona Road (3,500 cars per day) and Lacy Road (3,500

cars per day).

Objective 7: This project is within the urban service area.

Policies:

(3) This project is within the urban service area.

Objective 8: This project is consistent with the recently amended map – High Density Residential.

Policies:

(1) PDD zoning is consistent with the High Density Residential

land use designation.

Natural Resources Goal 1:

This project will protect the natural environment.

Objective 3: This project will protect natural resources

Policies:

(1) This project will meet all current City stormwater control requirements.

- (2) This project will meet all current City erosion control requirements.
- (3) This project will meet all current Floodplain and Wetland ordinances. There are no floodplains or wetlands within the project boundary.
- (5) This project is not developed on private septic.
- (7) This project features stormwater infiltration.

Housing Goal 1:

This project will provide a much in-demand housing choice: Market-rate rental units.

Objective 1: After engaging nationally recognized residential experts Tracy Cross and Associates of Schaumburg, IL to perform a market study of alternative uses, they proposed a first class apartment home community. The three stories over underground parking, with 44 to 56 unit buildings, feature average residences of 929 square feet and average rent of \$1,150 per month. This market study and our business experiences of 25 years owning in excess of 4,000 apartment residences have determined this will be highly demanded, bring quality residents and a benefit to the City of Fitchburg.

Policies:

- (1) This project is an efficient use of land in the urban service area and provides for multi-modal friendly densities.
- (2) This project adds variety to the Quarry Vista neighborhood
- (4) This project will meet the demand of new employees within the Fitchburg/Verona area which is experiencing a significant influx of \$45,000 to \$80,000 per year jobs.

Housing Goal 2:

This project makes efficient use of land for housing.

Objective 1: This project is a compact neighborhood.

Policies:

- (1) This project is efficient to serve and this preserves rural land resources.
- (2) In order to provide a variety of housing units, we will be offering studio, one-bedroom, and two-bedroom units.
- (4) This infill project makes wise use of land in the current urban service area, where service provisions already occur.
- (5) We are proposing higher but livable residential density, which promotes wise use of the land resource and reduces land located elsewhere required to meet housing demand. This helps to preserve agricultural and other open space land outside the urban service area.
- (6) By utilizing the PDD design review process, the City will be allowed to ensure sound sustainable housing design.
- Objective 2: This residential development is occurring in an area with existing infrastructure and sewer.

Policies:

- (1) This residential housing project is located in an area served by full urban services, including sanitary sewers and public water within convenient access to community facilities, employment centers, and to arterial highways.
- (2) This project is not an unsewered subdivision.

Utilities Goal 2:

Existing urban services will be extended within the urban development boundary area as part of this project.

Objective 1: This project will improve the condition of the existing sanitary sewer and water infrastructure.

Policies:

(2) As part of the Quarry Vista development, both Lacy Road and Fitchrona Roads will have segments improved, including the addition of paved bike paths.

(4) Our entire project will be served with gravity flow sanitary sewer.

Objective 2: This project is being developed within the existing urban service area and adjacent to existing public infrastructure.

Policies:

- (1) Utilities will not be extended across substantial vacant land.
- (2) Water and sewer will be extended concurrently with new streets.
- (3) Utilities will not be placed in wetlands or other environmentally sensitive areas.

Transportation Goal 1:

This project is part of a coordinated land use and transportation system.

Objective 1: This project is a compact, urban development.

Policies:

- (1) This project features buildings closer to the sidewalks, street trees, street lighting, lower parking ratios, structured parking, and parking behind buildings.
- Objective 3: In conjunction with this project, the City has been coordinating with the Town of Verona on the roadway connections to Fitchrona Road.

Policies:

(2) The Quarry Vista project is dedicating appropriate road right-of-way for both Fitchrona and Lacy Roads.

Transportation Goal 2:

In conjunction with this project, a safe and efficient transportation system will be provided for the Quarry Vista neighborhood.

Objective 1: In conjunction with this project, the overall safety of the transportation system in the North Fish Hatchery Road corridor will be improved.

Objective 2:

In conjunction with this project, proper traffic management and travel time reliability will be improved in the Quarry Vista neighborhood.

Policies:

- (2) The pattern of streets and sidewalks in the project area will maximize the connectivity of land uses within the neighborhood and to areas outside the neighborhood.
- (6) This project will not have direct access to either Fitchrona or Lacy Roads.
- (7) This project will not have direct access to either Fitchrona or Lacy Roads.

LAND USE

When complete, this project will contain multi-family residential uses.

Outlot 9 / Proposed Lot 15 Land Use


This 4.84 acre parcel will be consistent with the City's Comprehensive Plan with a High Density Multi-Family Residential Use. It will have 152 residential apartment units along with their associated common amenity spaces. At the time of this Specific Implementation Plan, the mix of residential units is as follows:

Studio Units: 6%
1 or 1 Bedroom+Den Units: 58%
2 or 2 Bedroom+Den Units: 36%

Within each unit type there will be a variety of unit sizes - with an average unit size of approximately 929 square feet. This mix of unit types & sizes will serve a variety of potential residents.

In addition to the residential units themselves, Outlot 9 / Proposed Lot 15 will contain various common space amenities integrated within the buildings or around the site. At the time of this Specific Implementation Plan, the anticipated common amenities are:

- Pool with sundeck
- Business Center
- Fitness Center
- Clubroom with Kitchenette
- Walking Paths with Dog Stations
- Other Green and/or Open Space for passive and active activities

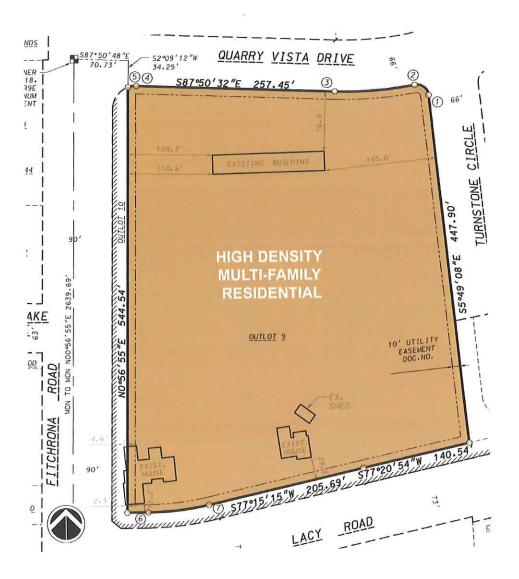

SITE DESIGN & ZONING STANDARDS


The Masterplan of Outlot 9 / Proposed Lot 15 has been thoughtfully designed to address numerous site challenges including the existing topography, storm water management, and project identity. See Appendix 'C' for the Specific Implementation Plan.

Masterplan Design Highlights:

- To work with the existing topography of the site, building pads are kept higher along the east property line, and lower along the west property line (Fitchrona Road) stepping down to the west.
- Storm Water Management Facilities are located to allow storm water to be collected on site.
- The buildings are located & orientated to address the street edge and to help define the public realm.
- Surface parking is kept to the interior of the site to reduce its visual impact from the public streets.
- Incorporating the storm water management pond as an amenity adjacent to the project's other common space amenities help give the project a distinct entry & identity.
- Pedestrian pathways not only connect the site internally, but also connect the project site with adjacent parcels.

Off Street Parking:

The City's typical parking requirements require two parking stalls per residential dwelling unit. Based on our extensive experience in owning & managing large multi-family communities, and considering the abovementioned unit mix, we find that this requirement would be excessive. Therefore, we are proposing a total of 1.5 parking stalls per dwelling unit with each one and two bedroom unit having one parking stall within the underground parking structure. We believe that providing this level of parking will be appropriate for this project, will allow the site to have less impervious area, and will minimize the visual impact of surface parking lots on the site and the surrounding areas.

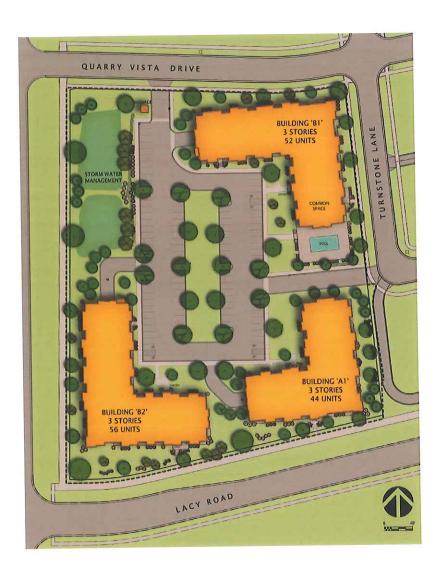

Bicycle Parking:

In addition to off street vehicular parking, we are proposing a total of 1.0 bicycle parking stalls per dwelling unit. Exterior stalls are located with proximity to each building's main entrance for easy access, while interior bike hooks are proposed above each Lower Level parking stall.

BUILDI	NG		BICYC	LE PARKING			
NAME UNITS		COVERED	SURFACE	TOTAL	RATIO		
A1	44	44	5	49	1.11	PER UNIT	
B1	52	52	5	57	1.10	PER UNIT	
B2	56	53	5	58	1.04	PER UNIT	
TOTALS	152	149	15	164	1.08	PER UNIT	

Storm Water Management Overview:

The following items are highlights of the Storm Water Management Design for the project:

- Storm water management will address peak control, water quality and infiltration.
- Peak control and water quality control from the dirty parking lots will occur within the wet portion of the detention pond.
- The development will take advantage of the native sandy soils and provide infiltration in a basin adjacent to the wet detention. All clean rooftop runoff from the buildings will be directed into the infiltration area that will be restored with native prairie plantings.
- All storm water management measures will meet or exceed the City of Fitchburg's ordinance requirements.
- The maintenance of all storm water management measures within Outlot 9 / Proposed Lot 15 will be the responsibility of the property Owner.

<u>Landscape Design:</u>

The new landscape design for Outlot 9 / Proposed Lot 15 of this project will meet all City of Fitchburg landscape design requirements. Please see Appendix 'C' for the Specific Implementation Landscape Plans for Outlot 9 / Proposed Lot 15. This plan will be further developed and additional detail and information will be provided with the subsequent Specific Implementation Plan submittals.

Open Space & Recreational Space:

Each building in the Masterplan of Outlot 9 / Proposed Lot 15 is designed with adjacent open space for passive, flexible recreation. Additionally, the upper and lower surface parking lots are separated by a central green space.

Refuse & Recycling Storage & Removal:

Each building within the development will have refuse & recycling rooms within the buildings themselves located on the Lower Level near the ovearhead door entrance. A private waste management company will be

contracted with to provide recycling & refuse removal services as appropriate for the development.

Planned Development Zoning Standards

Under the proposed Planned Development Zoning, Outlot 9 / Proposed Lot 15 shall meet the following Zoning Standards:

Residential Density:

32 units per acre (maximum)

• Building Height:

Maximum of 3 Stories over Parking <u>and</u> Maximum 60 feet (to highest roof ridge)

Street Setback:

10' (minimum), 15' (minimum at Fitchrona Rd.)

Exterior Stairs, Entry Stoops, Planters, and overhangs are permitted to encroach within

this Setback

Side Yard Setback:

10' (minimum)
10' (minimum)

Rear Yard Setback:Building Coverage:

32% of Parcel Area (maximum)

Floor Area Ratio:

1.00 (maximum)

Impervious Surface Ratio:

60% of Parcel Area (maximum)

Off-Street Auto Parking:

1.5 (min), 1.75 (max.) Total Spaces per Dwelling Unit

0.9 Structured Spaces per Dwelling Unit (min.)

Off-Street Bicycle Parking:

1.0 Bike Spaces per Dwelling Unit (min.)

Specific Implementation Plan Data

At the time of this Specific Implementation Plan, the Outlot 9 / Proposed Lot 15 Masterplan Data is as follows. The exact data (below) is subject to change slightly as the project's design is further developed; however, the final data shall meet all Specific Implementation Plan Zoning Standards (above).

	BUILDI	NG					P/	ARKING	
NAME	USE	FOOTPRINT	FLOOR ARE	A	UNITS	COVERED	SURFACE	TOTAL	RATIO
A1	Multi-Family Residential	18,179 S.F.	51,393	S.F.	44	44	26	70	1.59 PER UN
B1	Multi-Family Residential	22,079 S.F.	62,247	S.F.	52	52	32	84	1.62 PERUN
B2	Multi-Family Residential	22,063 S.F.	62,247	S.F.	56	53	31	84	1.50 PER UN
TOTALS		62,321 S.F.	175,887	S.F.	152	149	89	238	1.57 PER UN

ZONING REQUIREMENT	DESIGN VALUE	CALCULATIONS
SITE DENSITY	31.40 Units/Acre	152 Units / 4.84 AC. = 31.40
BUILDING COVERAGE	29.6% of Parcel	62,321 S.F. / 210,871 S.F. = 29.6%
FLOOR AREA RATIO	83.4% of Parcel	175,887 S.F. / 210,871 S.F. = 83.4%
IMPERVIOUS SURFACE	57.1% of Parcel	120,350 S.F. / 210,871 S.F. = 57.1%
LANDSCAPE AREA	42.9% of Parcel	90,521 S.F. / 210,871 S.F. = 42.9%

MASTER SIGN PROGRAM

In addition to address signage which will be mounted on each respective building, the permanent exterior signage for the project will consist of three (3) exterior signs that total 127.9 square feet of signage area at project completion. During the construction of the project, there will be four (4) temporary signs used. The location and design of these signs are specifically illustrated in Appendix 'D' – Master Sign Program. In summary, they will be made up of the following:

- 1.) One (1) Auxiliary Sign to provide direction to & from the Leasing Office will be located at the north end of the parking lot. This sign will have a signage area of 6 square feet. Please note that this square footage does not include the mounting posts below the sign areas (See Directional Sign D in Appendix 'D').
- 2.) One (1) Monument Sign will be located at the southeast intersection of Quarry Vista Drive at Fitchrona Road. This sign will be 72 square feet. (See Location A Sign in Appendix 'D').
- 3.) One (1) Monument Sign will be located at the northwest corner of the Building 'B1' along Quarry Vista Drive. This sign will be 48.9 square feet (See Location C Sign in Appendix 'D').
- 4.) Also note that Locations A, B, C, and D will host temporary leasing and directional signs, which will be removed by project completion. (See Appendix 'D').

ENVIRONMENTAL BENEFITS OF PLANNED DEVELOPMENT ZONING

The Environmental Benefits of using Planned Development District Zoning for this project come from the greater flexibility in both density & zoning standards that is allowed under PDD Zoning than would be allowed under the City's High Density Residential Zoning.

Reduction of Sprawl

Because of PDD Zoning, more units can be developed on this site. Therefore, this development can help meet the increasing need for residential units on less land area than would be otherwise be required under the City's High Density Residential Zoning.

Less Impervious Surface Area

The Parking Standards for PDD Zoning allow the Plan Commission to approve greater flexibility in the amount of vehicular parking that must be provided on site. In our Development Team's experience, the parking requirements of the City's High Density Residential Zoning District are excessive for this project - and would result in more impervious surface area across the site than what our plan proposes. Utilizing PDD Zoning for this project will decrease run-off and allow additional landscaped areas.

Enhanced Public Realm

With PDD Zoning, the site can be designed to enhance the character and visual aesthetics of the public realm. Under PDD Zoning, the building setbacks can be reduced to allow the buildings to be located & orientated to address the street edge and to help define the public realm. This also provides additional land area behind the buildings - so surface parking can be kept to the interior of the site and reduce its visual impact on the public streets.

ORGANIZATIONAL STRUCTURE

This project will be professionally owned and managed by an entity controlled by Fiduciary Real Estate Development, Inc.

At Fiduciary, we have a long track-record of successful property development & management throughout Wisconsin - including Fitchburg. We take pride in our great reputation, and the relationships we have with our employees, our residents, and the communities in which we are located.

Supervision

We have the most experienced, well-trained supervisory employees.

- We have Corporate reviews for each property on a bi-monthly basis and are updated daily on emergency maintenance issues.
- Each Regional Supervisor oversees 3 to 5 properties and visits each property at least once per week. This keeps them in touch with their properties and holds each on-site Property Manager accountable.
- Each on-site Property Manager conducts a daily staff meeting and is the key contact person for each property.
- We maintain continual maintenance personnel communication so we are on top of all existing or potential maintenance issues.
- We implement thorough bi-monthly property inspections for each property.

<u>Training</u>

We implement a proven training program for our employees to make sure everyone knows their role and performs their responsibilities as expected.

- We maintain a 300-page manual for property management. It is a 'living document' that is updated at semi-annual manager meetings.
- We employ onsite training by both Regional supervisor and property managers.

Applicant Screening

To help ensure that we are attracting quality residents, we obtain the following information from prospective residents:

- Criminal background checks
- Credit checks
- Recommendations/Referrals of previous landlords
- Income qualifications & verifications

Track-Record of Success

We have a long track-record of successful property development & management. The key to our long-term success of multi-family residential communities is the continual reinvestment in the properties. We continually evaluate the need to upgrade & improve our properties - to maintain them as highly desirable communities that attract quality residents. For example, in the past five years at our Valley View Apartment project in Fitchburg, we have spent \$1,400,000 on roofing, siding, pool improvements, a Wi-Fi Café, and a Fitness Center. This year we are working on upgrading individual units and common area carpets.

According to Kathy Nettesheim, Vice President of Property Management, another key to success is having excellent relationships with the communities in which we are located. We have found that the City of Fitchburg is one of the best communities that we work with – our communication is often and thorough.

PROJECT IMPLEMENTATION

At the time of this Specific Implementation Plan, we are working with the Department of Public Works to determine the specific timeline for public improvements for this project. Quarry Vista subdivision improvements, including the Fitchrona Road water main, are expected for completion by Summer 2015.

The construction of the apartment buildings is anticipated to follow the following schedule in one single phase with completion in Fall 2016:

<u>Phase</u>	<u>Buildings</u>	<u>Schedule</u>
Phase 1	'B1'	(anticipated for Summer 2015)
Phase 1	'B2'	(anticipated for Summer 2015)
Phase 1	'A1'	(anticipated for Fall 2015)

However, the residential market demand will ultimately drive the overall schedule and could speed-up or slow down the timeline for full build-out.

NEIGHBORHOOD INPUT

On October 3, 2014, we mailed out a letter and an area map (an example of each is attached in Appendix 'E') to all owners of property within 300 feet of our project. The letter invited comment, as well as attendance, at a meeting held at the Hammersley Stone Offices on Tuesday, October 14, 2014 at 5:30 PM. At this meeting, we had nine people representing the neighboring properties (see the meeting sign-in sheet in Appendix 'E'). We provided a brief overview of our project and answered questions.

APPENDIX 'A' ALTA SURVEY & AERIAL CSM

SURVEYOR'S CERTIFICATE

FO: Fiduciary Real Estate Development. Inc. Knight Barry Title Group

This is to certify that this map or plat and the survay on which it is based were made in occordance with the 2011 "Minimum Standard Detail Requirements for ALIA/ACSM Land Titla Surveys", jointly established and adopted by ALIA and MSFS, and includes items 1, 4, 8, 8 lifel Table A thereof. The field work was completed on May 29, 2014.

Dated this 6th day of Jone, 2014





NOTES

- 1. This survey was performed over Outlot 9 of the proposed Quarry Vista plat.
- 2. Survayed for: Fiductory Real Estate Development 789 North Water Street, Suite 200 Milwaukee, WI 53202

LEGAL DESCRIPTION

Port of Lots 1, 2 and 3, Certified Survey Map No. 11159 recorded in Volume 67 of Certified Survey Maps on pages 152–154 as Document Number 3959694. Dane County Registry, located in the NW1/4 of the NW1/4 of Section 18, T6N, 9E, City of Fitchburg, Dane County, Wisconsin to-wit:

27.59 feet: thanse N00°56'55"E. 544.54 feet to the point of beginning. Confaining 210.87! square feet (4.84) acres).

ITTLE COMMITMENT

Disposition of Exceptions Identified in Schedule 8 - Part II Commitment for Iltio Insurance Issued by Kniphi Berry Iltio Group Commitment date May 15, 2014 Title Insurance Filo No. D719910


EXCEPTION:

- 1-11-19-20 &21. These items are statements, standard exceptions or financial matters which cannot be plotted on this survey.
- 12. Edsements, restrictions and other matters shown on Cartified Survey Map No. 11159 recorded August 26. Edsements: restrictions and other matters shown on Cartified Survey Map No. 11159 recorded August 2 2004 as Document No. 3959694. Notes on CSM: 1. No other permit or approval is waived or deemed satisfied except for the approval herein provided 2. House on Lat 1 is nonconforming as to the slda street (Fitchrona Road) setback in the R-L District. -Affect subject parcel, not plottable.
- Order Establishing Utility District recorded February 28. 1969. as Document No. 1235025. -Affects subject parcal. not plottable.
- 14. Notice Affecting Real Estate Situated within the Town of Fitchburg dated September 21, 1978 and recorded Suprember 21, 1978 in the Diffice of the Register of Deeds for Bone County in Voluma 996 of Records, page 8 as Decument No. 1592785.


 -Affects subject parcel, not plottoble.
- 15. Notice Affecting Real Estate situated within the Town of Fitchburg dated September 21. 1978 and recorded September 25. 1978 in the Office of the Register of Deeds for Dane County in Valume 396 of Records, page 652 as Document No. 1593197.

 -Affects subject parcel, not plattable.
- 16. Ordinance recorded on August 8, 1969 as Document No. 1247637, -Affects subject parcellinot piottable.
- Resolution and Order Aftering the Boundary lines of Fitchburg Utility District No. 1. recorded in Volume 27371 of Records, page 43 as Document No. 2599374. -Located on land east of the subject parce!
- Individual Conveyance of Easement recorded on April 16, 2002 as Document No. 3475850.
 Is not located on subject parcel. Located within the current Fitchrona Road right-of-way.
- Mortgaga from Hamm Fam Lund, LLC to Independent Bank in the amount of \$300.000.00 dated December 8. 2004 and recorded December 13, 2004 as Document No. 4000303. (Lots 2 and 3 CSM 11159).
- Assignment of Rents from Hamm Fam Land. ELC to Independent Bank recorded December 13, 2004 as Document No. 4000304. (Lots 2 and 3 CSM 11159).
- Mortgage from Nathan Hammersley and Jane Hornobrook to Mortgage Electronic Registration Systems. Inc.
 acting solely as a nominee for Lender, Countrywide Bank, FSB. and its successors and assigns. In the
 amount of \$186,000.00 dated January 23, 2006 and recorded January 29, 2006 as Document No. 4392314.

The mortgage described above was assigned of record to Federal National Mortgage Association by an instrument recorded November 1. 2012 in Document No. 4928653.

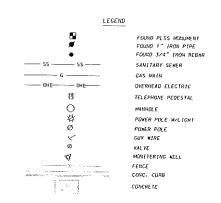

/USER/1403104/DRAWINGS/ALTA.DWG

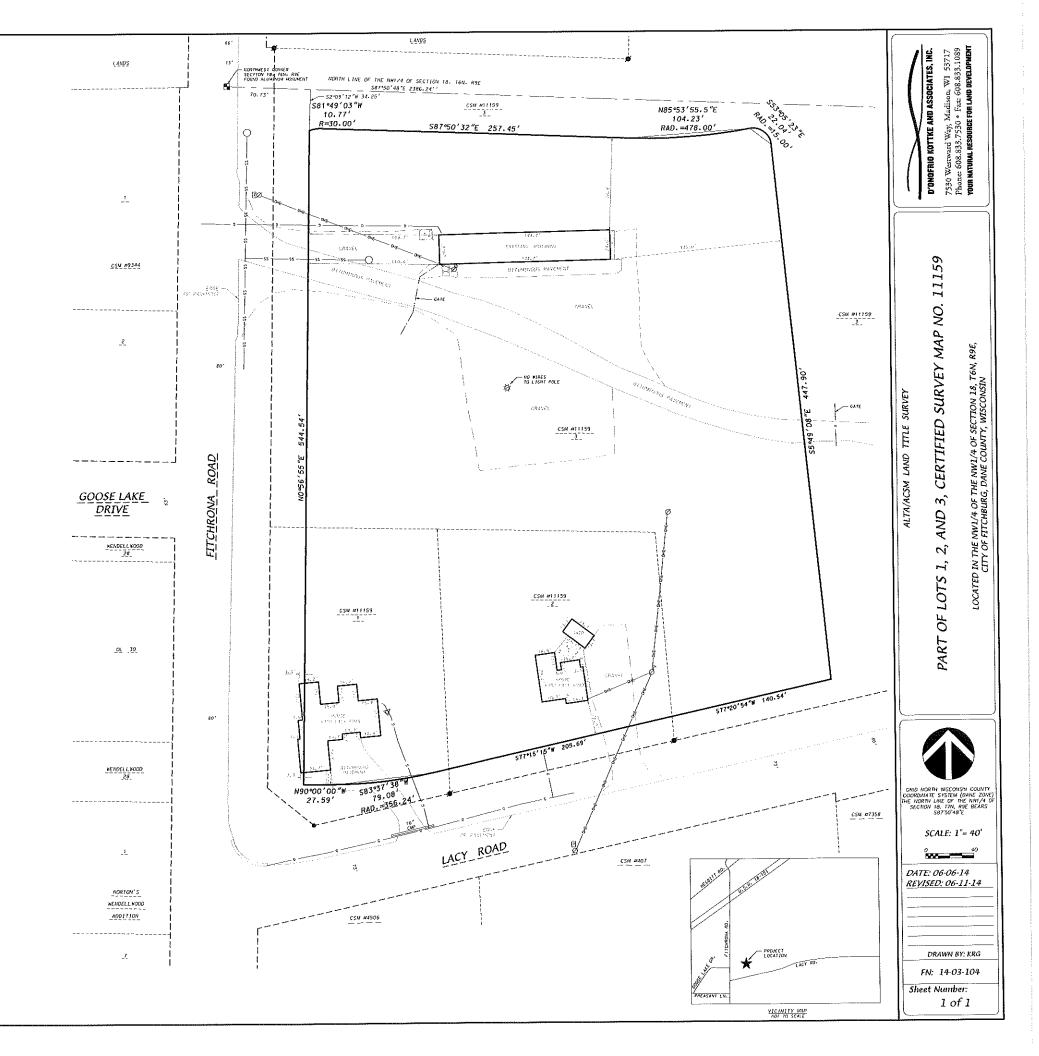



APPENDIX 'B' GENERAL DEVELOPMENT PLAN RECORDING

Planned Development District Granting General Implementation Plan Zoning for Portion of Quarry Vista Plat, Part of Lots 1, 2 and 3 CSM 11159



KRISTI CHLEBOWSKI DANE COUNTY REGISTER OF DEEDS

DOCUMENT # 5118141

12/18/2014 11:37 AM Trans. Fee: Exempt #: Rec. Fee: 30.00 Pages: 5

Legal Description:

Part of Lots 1, 2 and 3, Certified Survey Map No. 11159 recorded in Volume 67 of Certified Survey Maps on pages 152-154 as Document Number 3959694, Dane County Registry, located in the NW1/4 of the NW1/4 of Section 18, T6N, 9E, City of Fitchburg, Dane County, Wisconsin to-wit:

Return to: Fitchburg City Clerk 5520 Lacy Road Fitchburg, WI 53711

Parcel No: 060918285602 060918285802 060918286002

Commencing at the Northwest corner of said Section 18; thence S89°50'48"E, 70.73 feet along the North line of said NW1/4; thence S02°09'12"W, 34.25 feet to a point of curve also being the point of beginning; thence Easterly along a curve to the right which has a radius of 30.00 feet and a chord which bears N81°49'03"E. 10.77 feet; thence S87°50'32"E, 257.45 feet to a point of curve; thence Easterly along a curve to the left which has a radius of 478.00 feet and a chord which bears N85°53'55.5"E, 104.23 feet to a point of curve; thence Southeasterly along a curve to the right which has a radius of 15.00 feet and a chord which bears S53°05'23"E, 22.04 feet; thence S05°49'08"E, 447.90 feet; thence S77°20'54"W, 140.54 feet; thence S77°15'15"W, 205.69 feet to a point of curve; thence Southwesterly along a curve to the right which has a radius of 356.24 feet and a chord which bears S83°37'38"W, 79.08 feet; thence N90°00'00"W, 27.59 feet; thence N00°56'55"E, 544.54 feet to the point of beginning. Containing 210,871 square feet (4.841 acres).

Plan Commission Initiated By

Susan B. Badtke Drafted By

> 11/4/2014 Date

ORDINANCE NO. 2014-0-37

ZONING ORDINANCE AMENDMENT

GRANTING GENERAL IMPLEMENTATION PLAN ZONING

FOR PORTION of QUARRY VISTA PLAT, PART of LOTS 1, 2 & 3 CSM 11159

WHEREAS, pursuant to Fitchburg Ordinance No. 87-0-06, Section 3, Zoning District Maps were adopted within the corporate limits of the City of Fitchburg until expressly altered by the City Council, and



Ordinance 2014-O-37 Page 2 of 5

WHEREAS, Fiduciary Real Estate Development, Inc. has submitted an application (RZ-2043-14) for Planned Development District General Implementation Plan (PDD-GIP) zoning for part of lots 1, 2 and 3 CSM 11159, and

WHEREAS, the Plan Commission has reviewed, after public hearing on November 18, 2014, the application in accord with ordinance standards and recommends approval of PDD-GIP zoning for part of lots 1, 2 and 3 CSM 11159, with the area more particularly described in Exhibit A.

NOW THEREFORE the City Council of the City of Fitchburg, Dane County, Wisconsin does ordain as follows:

- (A) PDD-GIP zoning is hereby granted for part of lots 1, 2 and 3 CSM-11159 as particularly described in Exhibit A, and in accord with submitted plans and information which accompanied the rezoning application in a report titled "Quarry Vista Apartment Homes General Implementation Plan Amended November 5, 2014" received on November 4, 2014. The documents referred to above are hereby made a part of this ordinance, and with the following additional requirements:
 - . Approval and recording of a land division will be required prior to SIP issuance.
 - Recording of a Subdivision Improvement Agreement.
 - Necessary public improvement shall be installed and accepted prior to any building construction, unless approvals are granted to allow early start under section 24-14(b) – (e). (An operable public water supply is one necessary condition under section 24.14.)
 - Park requirements and fees shall be calculated and handled with land division approval.
 - 5. Signage shall be handled during the PDD-SIP (Planned Development District Specific Implementation Plan) zoning.
 - Project is approved for 152 dwelling units in 3 structures.
 - Zoning standards shall follow those outlined in the report titled "Quarry Vista Apartment Homes General Implementation Plan – Amended November 5, 2014".
- (B) This ordinance shall take effect following its publication, the consent of the property owner, or the recording of a plat, whichever occurs last. However, in accord with section 22-596 of the zoning code, owners shall consent within 30 days of approval for the PDD-GIP zoning to be in effect.
- (C) Applicant shall pay cost of ordinance publication to avoid a two Council meeting approval process.
- (D) Approval of preliminary and final plats by the Common Council.

Ordinance 2014-O-37 Page 3 of 5

The above and foregoing ordinance was duly adopted by the City Council of the City of Fitchburg, at a regular meeting held on the 25th day of November, 2014.

Patti Anderson, City Clerk

Shawn Pfaff, Mayor

STATE OF WISCONSIN)ss.
COUNTY OF DANE

Approved: 12-2-14

Personally came before me this and day of the City Clerk and Mayor (respectively) of the City of Fitchburg, and the persons who executed the foregoing instrument and acknowledged the same.

Notary Public, State of Wisconsin

Printed Name of Notary Public

My Commission Expires: 18, 2016

Consent of the Property Owner

Name: Keith & Harring Ally

Date: 12/08/2014

Title Managing Mencke

STATE OF WISCONSIN)ss. COUNTY OF DANE

Personally came before me this & day of

December, 2014, the

NOTARY PUBLIC

above named Keith E. Hammersley to me known to

be <u>Member</u>, of <u>Hanish Fan Saulle</u> and the person who executed the foregoing instrument and acknowledged the same.

Notary Public, State of Wisconsin

Printed Name of Notary Public / / My Commission Expires: 12/18/16

ELI K. DURG.
NOTARY
STEPHON MISCONER

Ordinance 2014-O-37 Page 4 of 5

Consent	of	Mortgage	Holder:
---------	----	----------	---------

Mortgage Holder Schuckarch Date: 12-8-14 Mortgage Holder Schuckarch, School Vice President Many & Schuckarch, School Vice President

STATE OF WISCONSIN)ss. COUNTY OF DANE

Personally came before me this <u>\$\frac{1}{5}\$</u> day	of <u>December</u>	_, 2014, the	above n	amed
Mary B. Schuchardt	to me known to be the	Serior	Vice	Pres
	nd the person who executed	the foregoin	g instrui	ment
and acknowledged the same.				
Carllantee				
Notary Public, State of Wisconsin				
	III Was			
Printed Name of Notary Public CWN	SI Van Pie	······································		
Printed Name of Notary Public CWN My Commission Expires: 3 13 16				




Ordinance 2014-O-37 Page 5 of 5


Exhibit A-Legal Description

Part of Lots 1, 2 and 3, Certified Survey Map No. 11159 recorded in Volume 67 of Certified Survey Maps on pages 152-154 as Document Number 3959694, Dané County Registry, located in the NW1/4 of the NW1/4 of Section 18, T6N, 9E, City of Fitchburg, Dane County, Wisconsin to-wit:

Commencing at the Northwest comer of said Section 18; thence S89°50'48"E, 70.73 feet along the North line of said NW1/4; thence S02°09'12"W, 34.25 feet to a point of curve also being the point of beginning; thence Easterly along a curve to the right which has a radius of 30.00 feet and a chord which bears N81°49'03"E. 10.77 feet; thence S87°50'32"E, 257.45 feet to a point of curve; thence Easterly along a curve to the left which has a radius of 478.00 feet and a chord which bears N85°53'55.5"E, 104.23 feet to a point of curve; thence Southeasterly along a curve to the right which has a radius of 15.00 feet and a chord which bears S53°05'23"E, 22.04 feet; thence S05°49'08"E, 447.90 feet; thence S77°20'54"W, 140.54 feet; thence S77°15'15"W, 205.69 feet to a point of curve; thence Southwesterly along a curve to the right which has a radius of 356.24 feet and a chord which bears S83°37'38"W, 79.08 feet; thence N90°00'00"W, 27.59 feet; thence N00°56'55"E, 544.54 feet to the point of beginning. Containing 210,871 square feet (4.841 acres).

APPENDIX 'C' SPECIFIC IMPLEMENTATION PLAN

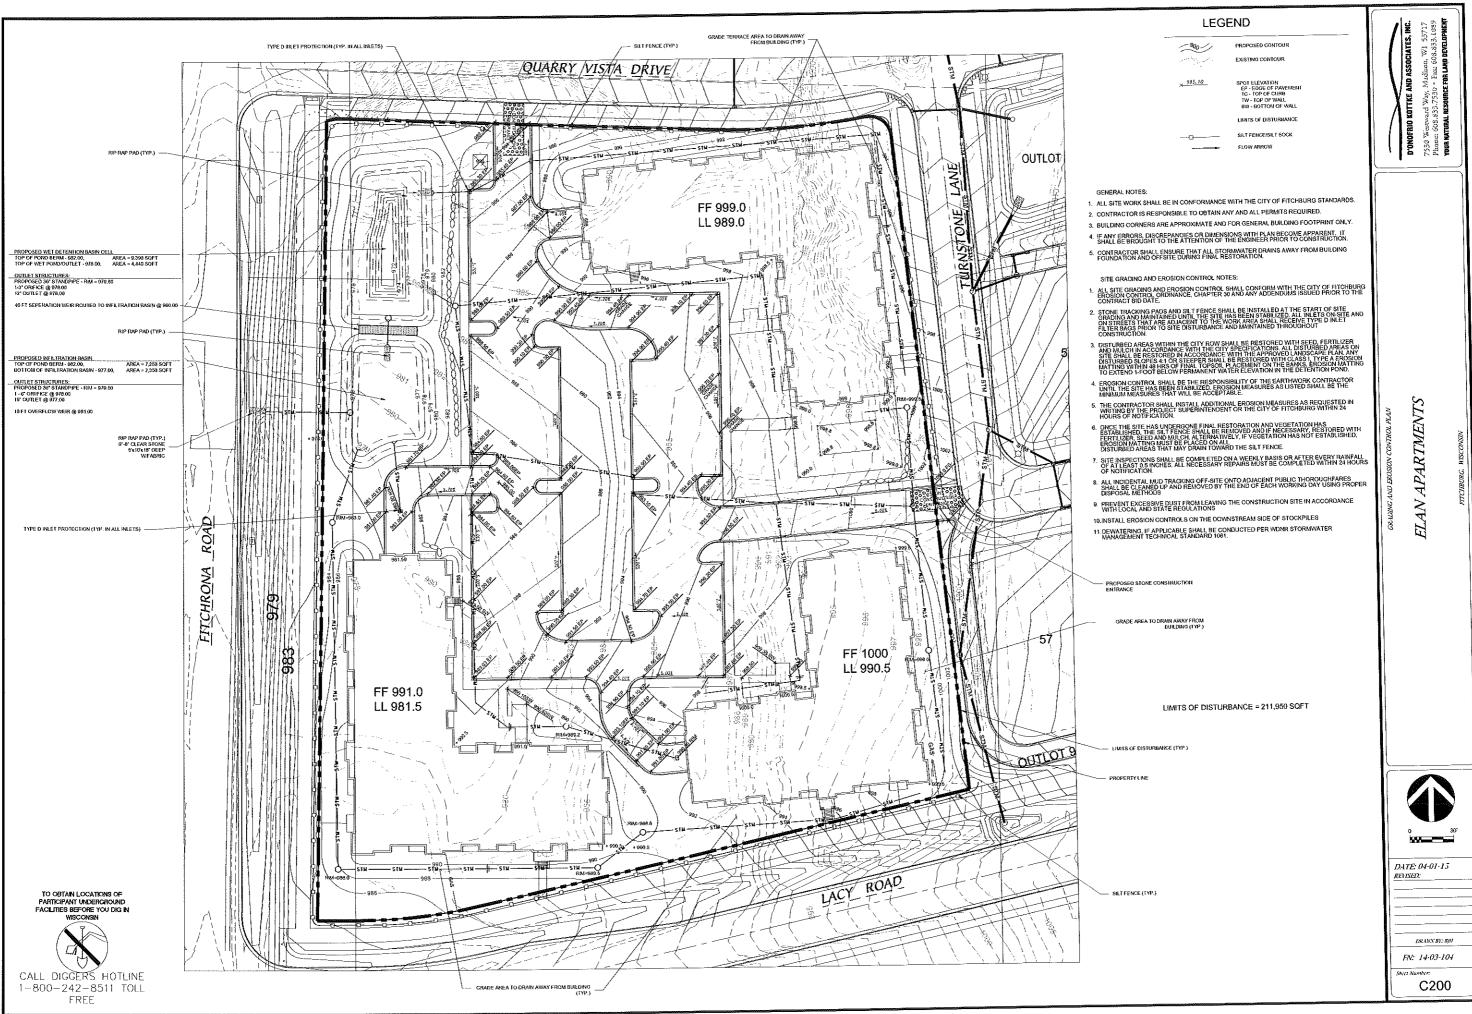

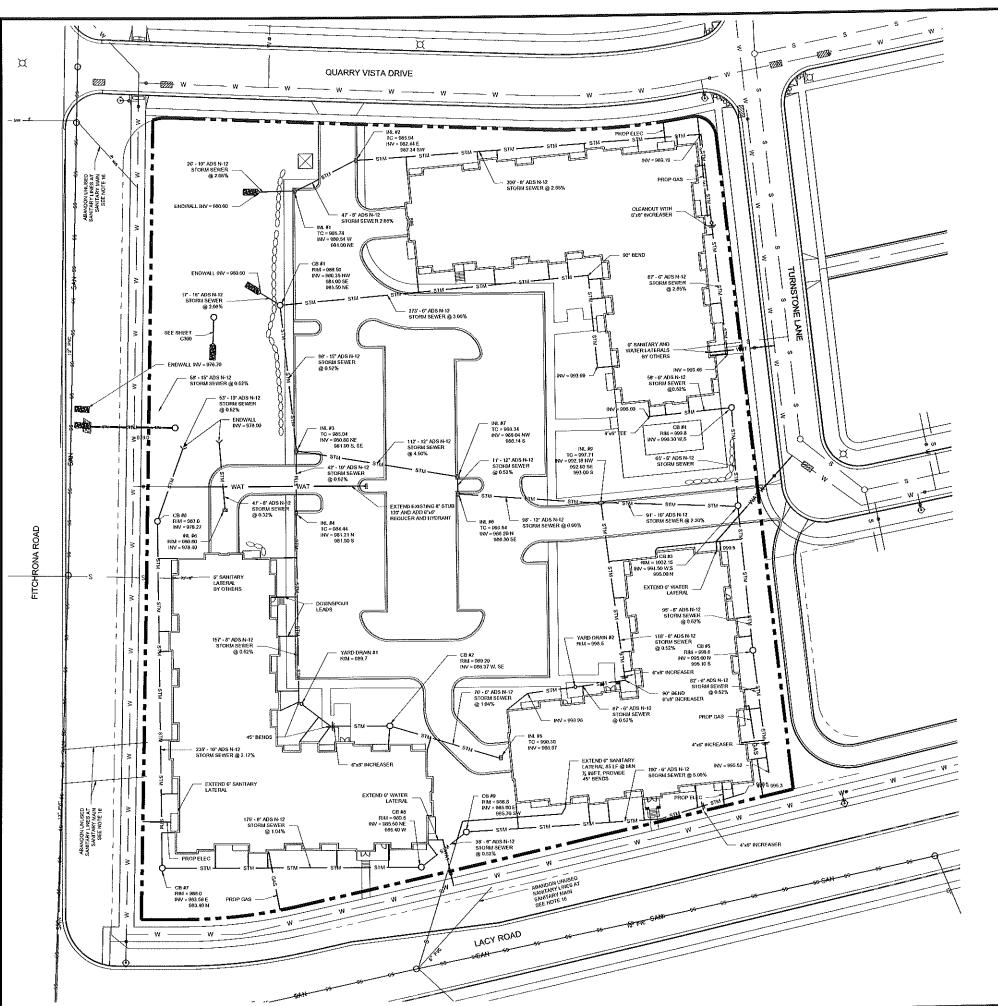

UTILITY NOTES:

- ALL STORM SEWER AND SANITARY SEWER SHALL CONFORM TO THE STANDARD SPECIFICATIONS FOR SEWER AND WATER CONSTRUCTION IN WISCONSIN 6TH EDITION, INCLUDING ALL ADDENDUMS.
- 2. WATER MAIN SHALL BE INSTALLED IN ACCORDANCE WITH CITY OF FITCHBURG AND DIRECTANDADOS
- 3. WATER MAIN SHALL HAVE A MINIMUM 6.5' OF BURY TO TOP OF PIPE.
- CB #1 · #9 SHALL BE 36" DIAMETER PRECAST MANHOLES WITH NEENAH R-2560-D1 CASTING AND GRATE.
- 5. CB #1, #3, #6 #8 SHALL HAVE NEENAH R-1550 CASTING WITH SOLID LID.
- 6. CB #2, #4, #5, AND #9 SHALL HAVE NEENAH R-2560-DI CASTING AND BEEHIVE GRATE.
- INL#1 #4 AND #7 #9 SHALL BE 2' X 3' PRECAST STRUCTURES WITH NEENAH R-3067 FRAME AND GRATE.
- INL #5 AND #6 SHALL BE 2" X 3" PRECAST STRUCTURES WITH NEENAH R-1878-BTG FRAME AND GRATE.
- CONTRACTOR TO COORDINATE SANITARY LATERAL AND WATER SERVICE ROUTING AND BUILDING CONNECTION WITH PLUMBING PLAN PRIOR TO CONSTRUCTION.
- ALL STORM LEADS CONNECTED TO BUILDING DOWNSPOUTS TO BE 4" ADS N-12 STORM SEWER SLOPED AT 1/18 INFT WITH WYES INTO THE MAIN PARALLEL TO THE BUILDING
- PER CITY ORDINANCE, CONTRACTORS ARE NOT ALLOWED TO OPERATE CITY OWNED VALVES. CONTRACTOR SHALL CALL THE FITCHBURG UTILITY AT 270-4270 FOR OPERATION OF THESE VALVES.
- 12. UTILITY CONTRACTOR TO USE A CONCRETE APRON ENDWALL AT THE 15' DISCHARGE PIPE FROM THE INFILTRATION BASIN AND TIE INTO THE ADS N-12 STORM SEWER PIPE USING A CONCRETE COLLAR PER THE CITY OF FITCHBURG STANDARDS.
- ALL WATER SERVICES BETWEEN THE PUBLIC MAIN UP TO A PRIVATE FIRE HYDRANT ARE REQUIRED TO BE A MINIMUM OF 6" AND BE INSTALLED PER THE LATEST EDITION OF THE CITY OF FITCHBURG STANDARD SPECIFICATIONS FOR PUBLIC WORKS CONSTRUCTION
- SAFE SAMPLE RESULTS NEED TO BE PROVIDED TO THE FITCHBURG UTILITY PRIOR TO PRESSURE TESTING THE PRIVATE WATER MAINS.
- 15. IT IS THE CONTRACTOR'S RESPONSIBILITY TO VERIFY THAT THE EXISTING VALVES WILL HOLD THE PRESSURE TEST PRIOR TO CONNECTION. THE CITY IS NOT RESPONSIBLE FOR ANY COSTS INCURRED DUE TO THE CONTRACTOR NOT VERIFYING THAT THE EXISTING VALVE WILL HOLD THE PRESSURE TEST PRIOR TO CONNECTION. IF A NEW VALVE IS REQUIRED, THE APPLICANT WILL BE REQUIRED TO INSTALL ONE AT THEIR EXPENSE AT THE POINT OF CONNECTION.
- 16. EXISTING SANITARY LATERALS, THAT WILL NOT BE REUSED, WILL NEED TO BE ABANDONED AT THE SEWER MAIN PER THE LATEST EDITION OF THE CITY OF FITCHBURG STANDARD SPECIFICATIONS FOR THE PUBLIC WORKS CONSTRUCTION. PUBLIC WORKS WILL NEED TO WITNESS THESE ABANDONMENTS.
- 17. ALL PRIVATE WELLS ON THIS SITE NEED TO BE ABANDONED PER DNR REQUIREMENTS. A DNR WELL ABANDONMENT FORM NEEDS TO BE SUBMITTED TO PUBLIC WORKS FOR EACH ABANDONED WELL.

D'ONOFRIO KOTTIKE AND ASSOCIATES, II
7530 Westward Way, Madison, WI 537
Phoens (68.833.750 v. Franches From Line) BEVILLE

ELAN APARTMENTS




DATE: 05-05-15 RE1/ISED:


RE17SED:

DR-101X BY: BJH
FN: 14-03-104

Sheet Number:

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WHEN REMOVING OR WAINTARNING WHET PROTECTION, CARE SHALL BE TAKEN SO THAT THE SEDWENT TRAPPED ON THE GEOTEXTHE FABRIC DOES NOT FALL NOT OTHER MEET, ANY MATERIAL FALLING INTO THE DIECT SHALL BE REMOVED IMMEDIATELY.

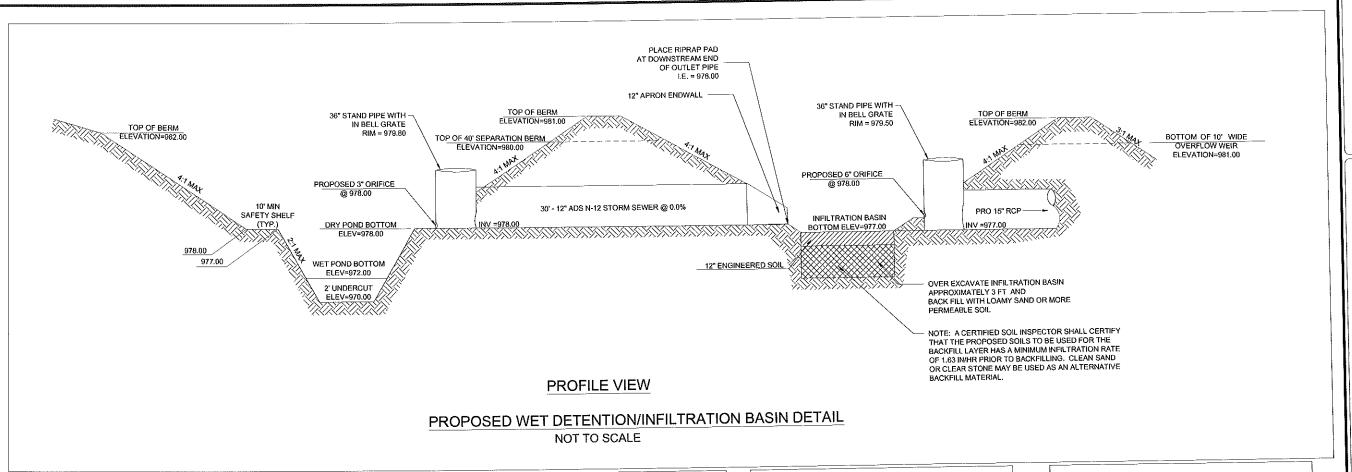
-) FINISHED SIZE, INCLUDING FLAP POCKEIS WHERE REQUIRED. SHALL EXTEND A MINIMUM OF 10° AROUND THE PERIMETER TO FACILITATE MINITEMANCE OF REMOVAL.
- (2) FLAP POCKETS SHALL BE LARGE ENOUGH TO ACCEPT WOOD 2X4.

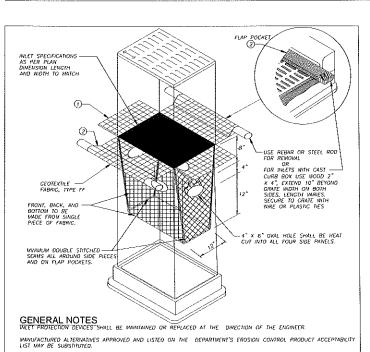
INSTALLATION NOTES
DO NOT INSTALL TREF PROTECTION TYPE D IN INLETS SHALLOWER THAN 30", MEASURED FROM THE BOTTOM OF THE
MAKET TO THE TOP OF THE GRATE.


TRIM EXCESS FABRIC IN THE FLOW LINE TO WITHIN 3" OF THE GRATE.


THE DISTALLED BAG SHALL HAVE A MINIMUM SIDE CLEARANCE, BETWEEN THE INLET WALLS AND THE BAG, MEASURED AT THE BOTTOM OF THE OVERFLOW HOLES, OF 3". WHERE NECESSARY THE CONTRACTOR SHALL CIRCH THE BAG, USING PLASTIC ZIP RES, TO ACHIEVE THE 3" CLEARANCE. THE TIES SHALL BE PLACED AT A MAXIMUM OF 4" FROM THE BOTTOM OF THE BAG.


INLET PROTECTION, TYPE D

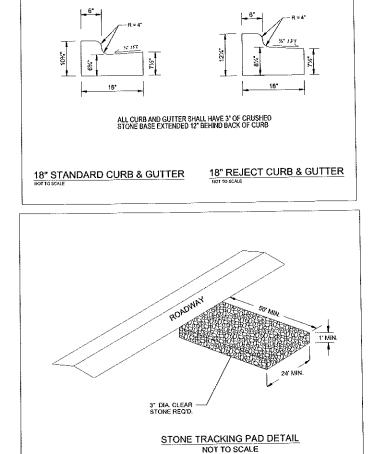

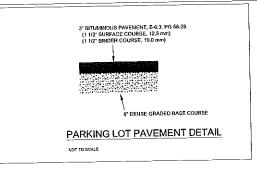

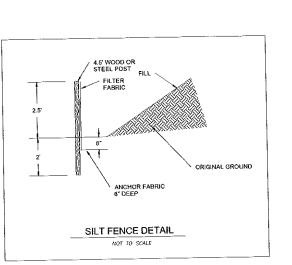


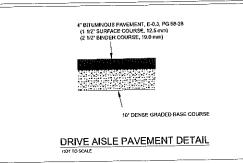

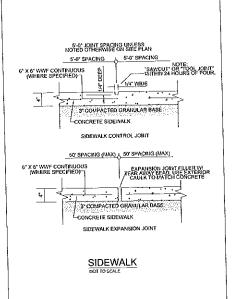


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AN APARTMENTS

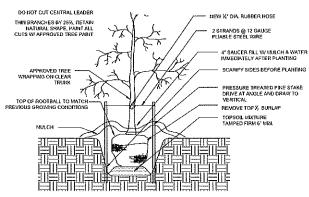


TREE PLANTING DETAIL

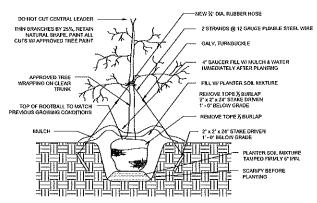


* TREES OF SAME SPECIES TO BE MATCHED IN GROWTH AND UNIFORMITY * PLANTING HOLE WIDTH SHALL BE THREE TIMES THE SIZE OF ROOTBALL.

TREE PLANTING DETAIL (TREES UNDER 2" CALIPER)

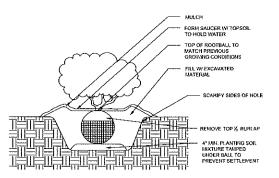

* SHRUBS OF SAMES SPECIES TO BE MATCHED IN GROWTH AND UNIFORMITY. * DO NOT PRUNE BEFORE ACCEPTANCE.

SHRUB PLANTING DETAIL

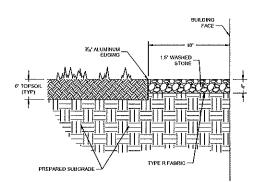

STONE MAINTENANCE EDGE

SITE LANDSCAPE PLAN - GENERAL NOTES

- 1. CONTACT DIGGER'S HOTLINE 3 WORKING DAYS PRIOR TO THE START OF CONSTRUCTION.
 2. CONTRACTOR SHALL VERIEY THE LOCATION OF ALL THE PRIVATE UTILITIES PRIOR TO THE START OF WORK.
 3. ALL LANDSCAPE BEOS SHALL CONTAIN A 3' DEPTH OF SHREDDED HARDWOOD BARK MULCH CONTAINED BY LANDSCAPE EDGING.
 4. LANDSCAPE EDGING SHALL BE ALUMINUM "CURV-RITE" EDGING.
 5. ALL TREES IN TURF AREAS SHALL HAVE A 5' DIAMETER CIRCLE OF 3' DEPTH SHREDDED HARDWOOD BARK MULCH.
 6. ALL LANDSCAPE AREAS HOT WITHIN A PLANTING BED SHALL BE FINISH GRADED, AND SEEDED WITH TURFGRASS SEED PER THE PROJECT MANUAL SPECIFICATIONS UNLESS OTHERWISE NOTED.
 7. INFILTRATION MIX SHALL CONFORM TO PRAIRIE NURSERY "MOIST MEADOW AND RAIN GARDEM MIX"
 8. ALL GENERAL LANDSCAPE AREAS SHALL HAVE A MINIMUM 6" COMPACTED DEPTH OF TOPSOIL.
 9. ALL LANDSCAPING SHALL BE IN ACCORDANCE WITH THE CITY ZONING ORDINANCE.
 10. SEE THE PROJECT MANUAL FOR SPECIFICATIONS AND REQUIREMENTS FOR PLANTING, STAKING OF TREES, WARRANTY PERIOD, MAINTENANCE, ETC.

 11. SEE DETAILS FOR PLANTING INSTALLATION.

QUARRY VISTA DRIVE

B-1

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A-1

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LANDSCAPE LIMITS TYP

I SHEET LIGH

		CONMONNAME	QTY	SUZE	ROOT	NOTES
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ECID	JOUS TREES	to de la company Consechara	4	8 TALL	68B	MALTISTER
ACA	Amelanchier x grandiflora 'Autumn Britiance'	Fall Fartasy Maple	8	25	BAB	
AFA.		Celebration Maple	5	25'	BAB	· · · ·
AFC		Karpick Red Maple	5	2.5	688	
ARK.		Pagoda Dogwood	5	8 TALL		MULTISTER
CA	Corrus attemitotia	JN Strain Musclewood	5	8 TALL		HALTISTER
ccı ·	Carpinus caroliniana 'JN Strain'	Northern Strain Redbud	4	B' TALL	888	MULTISTE
CCN	Cercis canadens is 'Northern Strain'	Litra Hackberry	8	2.5	B&B	,,,,,,,,,,
	Celis occidentalis "Litzam"		3	2.5°	BAB	
GBA	Ginkgo biloba 'Avismin Gold'	Autumn Gold Ginkgo	6	2.5	B\$9	
G8F	Ginlego biloba 'Princeton Sentry'	Princeton Sentry Ginkgo	7	2.6	BAB	
	Glecitsia triscanthos 'Shademaster'	Shademaster Honeylocust	6	B TALL		MATISTE
MPF	Matus 'Praine Fire'	Preine Fire Crabappie	4	25	889	MOE IF STE
NSW	Nyssa sylvatica 'Wildfire'	Wildfire Black Gum	6	8 TALL	B\$8	MULTISTE
ΟV	Ostrya virginiana	ronwood	5		BAB	MULTINATE
SRI	Syringa resculate 'ivory Pyter'	Ivory Pitar Japanese Tree Lilac	5	1.5	Ben	<u> </u>
VER	GREEN TREES				1	
	Ables concolor	Concolor Fir	7	8 TALL	858	
	Picea glauca var. densata	Black Hills Spruce	12	& LYIT	888	
	Pinus strobus	Eastern White Pine	4	8 TALL	888	1
ECIC	UQUS SHRUBS					
ALL	Aronia melanocarpa 'riquois Beauty'	riquios Seauty Chokeberry	5	36" TALL		
CSA	Cornes sericea 'Arctic Fire'	Arctic Fire Dogwood	11	36" TALL		4
FGB	Fothergiëa gerdenii 'Beaver Creek'	Beaver Creek Fothergia		18" TALL		ļ
HUA	Hydranges macrophylis 'As Summer Beauty'	All Summer Beauty Hydrengea	9	24" TALL		<u> </u>
POS	Physocarpus opulifolius 'Seward'	Summer Wine Ninebark	8	36°TALL		
RT	Rhus hiphina	Staghorn sumac	31	48" TALL		4
	Spiraea japonica "Magic Carpot"	Magic Carpet Spirace		12" TALL		
SP		Skoomerang Lifac	10			
	Viburrum cariesi	Koreanspice Viburnum	10	38 TALL		
VT	Viburnum trilobum 'Afredo'	Alfreado Cranberrybush Viburnum	7	48" TALL		
	Weigela 'Rumba'	Rumba Wekoola	11	24" TALL	POT	1
	GREEN SHRUBS					
^D/1	Chamaecypanis pisitera 'Golden Mops'	Golden Hops False Cypress	18			
Big	Juniperus horizontats 'Blue Chip'	Blue Chip Juniper	9	12" TALL		
ICUA.	Juniperus scoptionum Welchil	Welch Juriper	6	24" TAL		
2/0	Juniperus Virginiane Bue Mountain	Blue Mountain Juriper	17	24"TALI		
RP		P.IM Rhododendron	7	35° TALI	. POI	
	Tsuga canadensis 'Bennet'	Bennet Dward Cenadian Hemiock	21	24" TAL	. POI	
TMT		Teurson Yew	23	24" TAL1	L B&E	1
	Thuja occidentalis 'Holmstrup'	Holmstrup Arbon/lae	4	24" TAL	BAB	
	Thuis occidentals "Formstup"	Pyramidal Arborytae	29	48"TAL	. B&E	
108	I I II da occioentata sintrago	' Inministration		,		






ELAN APARTMENTS

DATE: 04-01-15 REVISED:

FN: 14-03-104

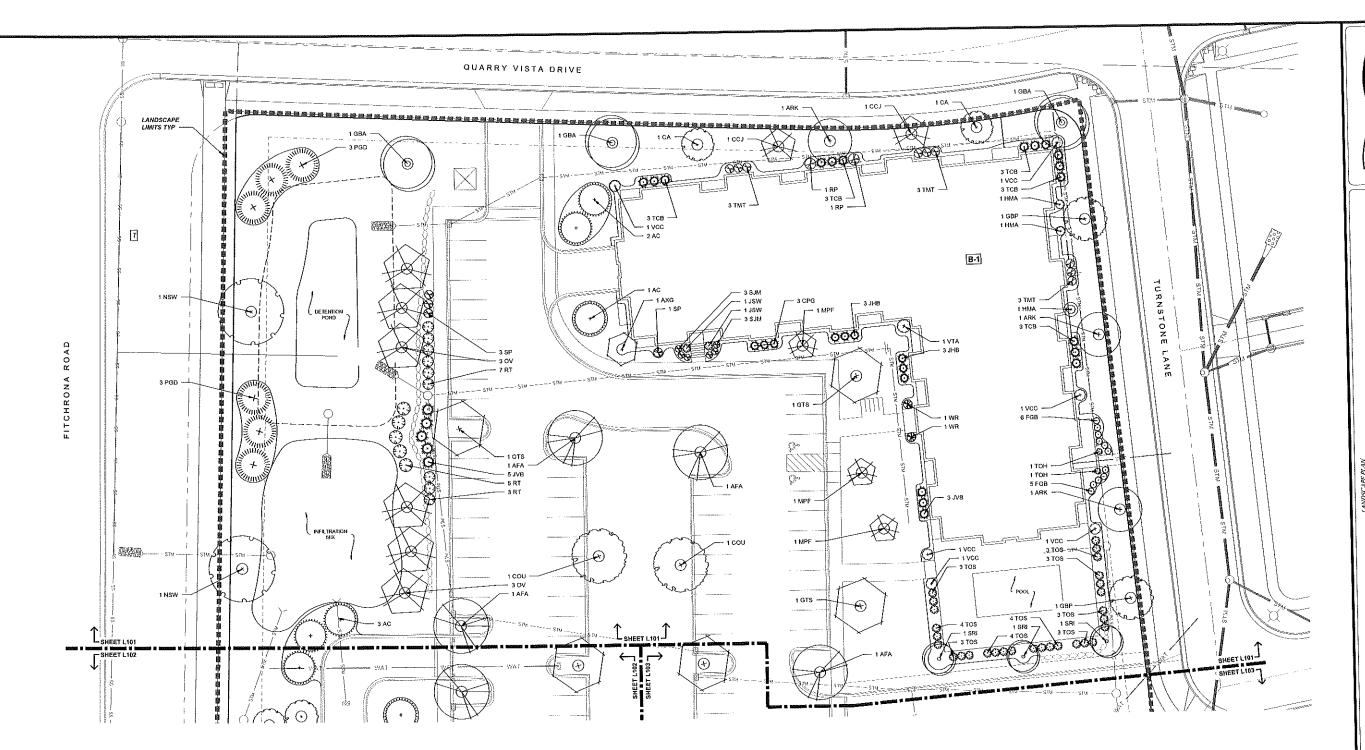

LANDSCAPE SCHEDULE

CODE	SCIENTIFIC NAME	COMMON HAME	ату	SIZE	ROOT	NOTES
DECID	VOUS TREES	•				
ACA	Amelanchier x grandifora 'Autumn Britiance'	Autmumn Britiance Serviceberry	4	B' TALL	B&8	MULTI-STEN
AFA	Acer x treemani 'Fat Fantasy'	Fall Fantasy Maple	8	25	888	
AFC	Acer x freemann 'Celzam'	Celebration Mapie	5	25"	BSĐ	
ARK	Acer rubrum 'Karpick'	Karpick Red Maple	5	25	889	
CA	Cornus aternifolia	Pagoda Dogwood	5	8 TALL	888	MULTI-STEA
CC1	Carpinus carpiniana 'JN Strain'	JN Strain Musclewood	5	8' TALL	888	MULTISTEA
CCN	Cercis canadensis 'Northern Strain'	Northern Strain Recibud	4	8 TALL	888	MULTI-STEA
COU	Cetis occidentata "Uzam"	Litra Hackberry	6	25	B&B	
G8A	Girkgo błoba "Autumn Gold"	Autumn Gold Cinkgo	3	25"	B&B	1
GBF	Ginkgo biloba 'Princeton Sentry'	Princeton Sentry Ginkgo	6	2.5	BAB	
GTS	Gleditala triacanthos 'Shademaster'	Shademaster Honeylocust	7	25	BSB	
MPF	Marus 'Praine Fire'	Pravie Fire Crabapole	8	8' TALL	888	MACTI-STEA
NSW	Nyssa sylvatica 'Wśdfre'	Włatke Black Gum	4	2.5"	B&B	
	Ostrya virginiana	ironwood	8	8 TALL	B&B	MULTI-STEM
SRI	Syrings reticulate 'kory Piller'	lvory Pifer Japanese Tree Litac	5	15"	888	
EVERO	REEN TREES				•	
AC	Abies concolor	Concolor Fir	7	8 TALL	B&B	
PGD	Picea glauca ver. densata	Black Hills Spruce	12	8 TALL	8&B	
	Pinus strobus	Eastern White Pine	4	B' TALL	888	1

CODE	SCIENTIFIC NAME	COMMON NAME	QTY	SIZE	COND	NOTES
DECID	UÇUS SHRUBS					
	Aronia melanocarpa 'iriquo's Beauty'	Viguéos Beauty Chokeberry	5	36" TALL	POT	
	Cornus sericea 'Arctic Fire'	Arctic Fire Dogwood	11	36" TALL	POT	
FGB	Fothergila gardenii 'Beaver Creek'	Beaver Creek Fothergiša	.17	18' TALL	POT	
	Hydrangea macrophylla 'All Summer Beauty'	All Summer Beauty Hydrangea	9	24" TALL	888	
POS	Physocarpus opulifolius 'Seward'	Summer Wine Nineback	В	38" TALL	POT	
	Rhus lyphina	Staghorn surnac	31	48 TALL	POT	
	Spraea japonica Wagis Carpet	Magic Carpel Spiraea	20	12 TALL	POT	
	Syringa 'Panda'	Stoomerang Litac	10	24" TALL	POT	
	Mournum carlesii	Koreanspice Viburnum	10	36 TALL	POT	
	Vibumum triobum 'Alfredo'	Afreado Cranberrybush Vournum	7	48' TALL	POT	
	Weige/a 'Rumba'	Rumba Weigela	11	24" TALL	POT	
	REEN SHRUBS					
	Chamaecyparis pisifera 'Golden Mops'	Golden Mops False Cypress	18	18" TALL	POT	
	Juniperus horizontalis 'Blue Chip'	Blue Chip Juniper	8	12" TALL	POT	
	Juniperus scopulorum Welchii	Welch Juriper	- 6	24" TALL	POT	
	Juniperus virginiana Blue Mountain	Blue Mountain Juniper	\$7	24" TALL	POT	
	Rhododendron "PJM"	P.J.J. Rhododendron	7	36" TALL	POT	
	Tauga canadensis Bennet	Bennet Dward Canadian Hemiock	21	24" TALL	POT	
	Taxus x media Taunioni	Taunton Yew	23	24" TALL	B&B	
	Their occidentals "Homstrup"	Holmstrup Arborvitae	4	24" TALL	BAB	
	Thuis occidentate 'Smarage'	Pyramidal Arborytae	29	48" TALL	BAB	

SITE LANDSCAPE PLAN - GENERAL NOTES

- CONTACT DIGGER'S MOTLINE 3 WORKING DAYS PRIOR TO THE START OF CONSTRUCTION.
 CONTRACTOR SHALL VERIFY THE LOCATION OF ALL THE PRIVATE UTILITIES PRIOR TO THE START OF WORK.
 ALL LANDSCAPE BEDS SHALL CONTAIN A 3" DEPTH OF SHREDDED HARDWOOD BARK MULCH CONTAINED BY LANDSCAPE EDGING.
 LANDSCAPE EDGING SHALL BE ALUMINUM "CURV-RITE" EDGING.
 ALL TREES IN TURF AREAS SHALL HAVE A 5" DIAMETER CIRCLE OF 3" DEPTH SHREDDED HARDWOOD BARK MULCH.
 ALL LANDSCAPE AREAS NOT WITHIN A PLANTING BED SHALL BE FINISH GRADED, AND SEEDED WITH TURFGRASS SEED PER THE PROJECT MANUAL SPECIFICATIONS UNLESS OTHERWISE NOTED.

 INFILTRATION MIX SHALL CONFORM TO PRAIRIE NURSERY "MOIST MEADOW AND RAIN GARDEN MIX"

 ALL GENERAL LANDSCAPE AREAS SHALL HAVE A MINIMUM 6" COMPACTED DEPTH OF TOPSOIL.

- TOPSOIL.

 ALL LANDSCAPING SHALL BE IN ACCORDANGE WITH THE CITY ZONING ORDINANCE.

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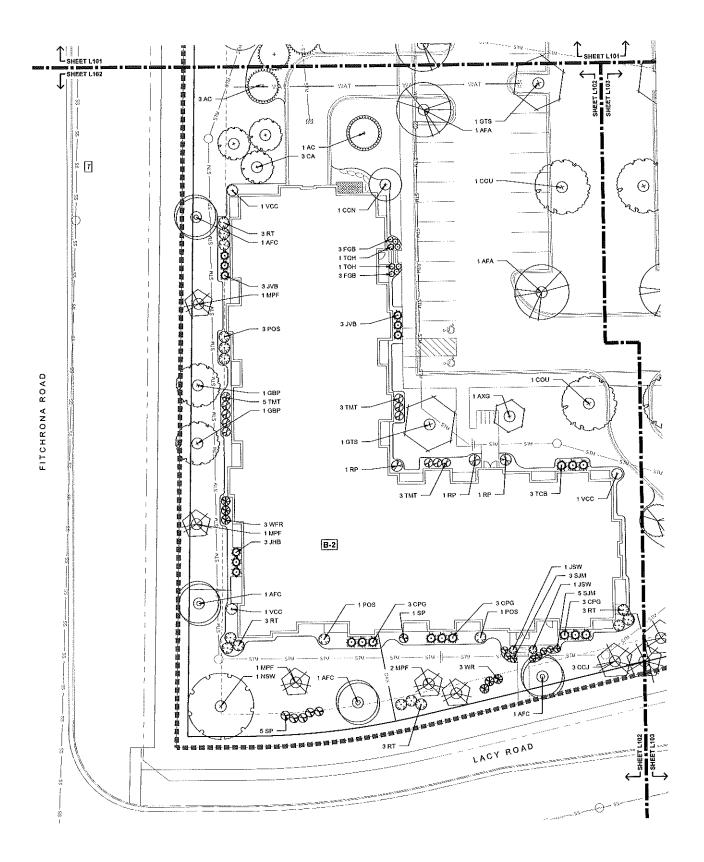
 11. SEE DETAILS FOR PLANTING INSTALLATION.



ELAN APARTMENTS

DATE: 04-01-15

FN: 14-03-104



SITE LANDSCAPE PLAN - GENERAL NOTES

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 6. ALL LANDSCAPE AREAS NOT WITHIN A PLANTING BED SHALL BE FINISH GRADED, AND SEEDED WITH TURFORASS SEED PER THE PROJECT MANUAL SPECIFICATIONS UNLESS OTHERWISE NOTED.
 7. INFILITRATION MIX SHALL CONFORM TO PRAIRIE NURSERY "MOIST MEADOW AND RAIN GARDEN MIX".

- 7. INFILITATION MIX SPALL CONFORM TO PROBLEM STATEMENT AND ALL GENERAL LANDSCAPE AREAS SHALL HAVE A MINIMUM 6" COMPACTED DEPTH OF TOP SOIL.

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LANDSCAPE SCHEDULE


		COMMON NAME	ατγ	SIZE	COND	NOTES
	ACIERTIFIC (CAME	COMMON NAME	MI II	3124.	COMP	
DECID	VOUS TREES	L. J Delinosa Canjestomy	4	8 TALL	BAS	MULTISTE
ACA	Amerianchier x grandiflora "Autumn Britiance"	Fall Fantasy Macle	8	25	B&B	
AFA.		Celabration Maple	5	2.5	BSB	
		Karoick Red Made	5	2.5"	888	†
ARK		Pagoda Dogwood	5	8 TALL		MATISTE
CA		JN Strain Musclewood	5	B TALL		MATISTE
CCT	Carpinus caroliniana 'JN Strain'	Northern Strain Redbud	4	6 TALL		MULTISTE
CCN	Cercis canadensis "Northern Strain"		6	25	839	INCCA GIL
	Cetts occidentalis "Utzam"	Utra Hackberry	3	25	BAB	
GBA	Girkgo biloha "Autumn Gold"	Autumn Gold Girkgo	6	25	B&B	
GBF	Girkgo biloha "Princeton Sentry"	Princelon Senitry Ginkgo	7	2.5"	848	
GTS	Glediala triacanthos 'Shademaster'	Shademaster Honeylocust		8 TALL		MULTISTE
MPF	Matus 'Prarie Fire'	Prairie Fire Crabappie	В	25	BAB	MULIFOIE
NSW	Nyssa sylvatica Widire	Wildfre Black Gum	4		BAB	MALTISTE
OV	Ostro virginiana	ronwood	8	8 TALL	BAR	MALIFOLE
SRI	Syringa reticulata 'tvory Pillar'	Nory Pitar Japanese Trea Lilac	5	1.5	PER	<u> </u>
EVER	GREEN TREES					
	Abies concolor	Concolor Fir	7	& LATT	BAB	
	Picea glauca yar, densata	Black Hills Spruce	12	8 TALL	BAB	
	Pinus strobus	Eastern White Pine	4	5 TALL	888	,i
	NOUS SHRUBS					
	Arona melanocarpa Viguo s Beauty	Iriquios Beauty Chokeberry	5	36" TALL		
	Comus serices 'Arctic Fire'	Arctic Fire Dogwood	11	36" TALL		
FCD	Fothergita gardenii 'Beaver Creek'	Beaver Creek Fothergila	17	16" TALL		1
FOR	Hydrangea macrophyla 'Ak Summer Beauty		9	24 TALL		
DOC	Physocarpus opulidius 'Seward'	Summer Wine Ninebark	8	36" YALL	POT	
RT		Staghom surnac	31	48' TALL	POT	T
	Spiraes japonica 'Vagic Carpet'	Magic Carpet Spiraea	20	12'TALL		
SP		Bloomerang Liac	10	24"TALL	POT	
	Vounum cariesii	Koreanspice Viburnum	10	36" TAL	POT	
		Afreado Crenberrybush Viburnun	7	48 TAL	POT	1
VI		Rumba Weigola	11	24 TAL	POT	
L WR	Wegela Rumba	Ruma Tregua	-1	1		
EVER	IGREEN SHRUBS	Golden Mops False Cypress	18	16" TAL	POT	
CPC	Chamaecyparis pisitera 'Golden Mops'	Blue Chip Juniper	9	12"TAL		
JHB	Juniperus horizontais 'Blue Chip'	Melcy Yrubes	- 6	24 TAL		
	/ Juniperus scopulorum Welchil	Blue Mountain Juriper	17			
		PUM Rhododendron	7	30 TAL		
RP		Bennet Dward Canadian Hemioc				
TCE	Tsuga canadensis 'Bennel'		23			
	Taxus x media Tauntonii	Taureton Yew	23			
TO	1 Thura occidentalis 'Holmstrup'	Holmstrup Arbonitae	29			
TOS	S Thura occidentalis 'Smarage'	Pyramidal Arborvitae	1 29	140 1AL	L D61	, L

ELAN APARTMENTS



DATE: 04-01-15

DRAWN BY: MS FN: 14-03-104

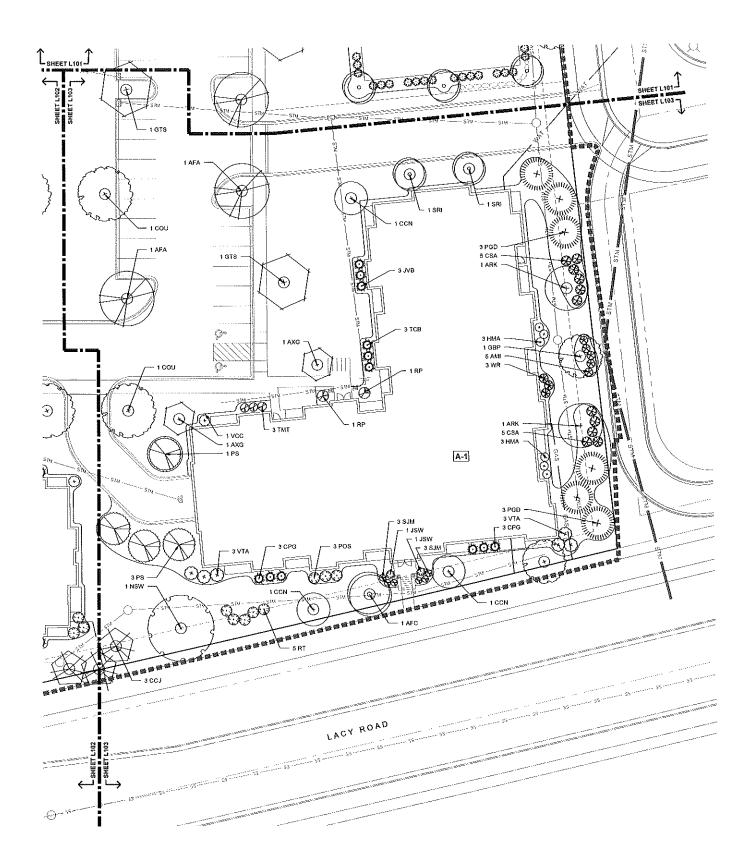

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LANDSCAPE SCHEDULE

-					ROOT	
CODE	SCIENTEFIC NAME	COMMON NAME	QTY	SCZE.	COND	NOTES
DEÇID	UOUS TREES					MATISTE
ACA	Amelanchier x grandifora 'Autumn Bhliance'	Autmumn Britiance Serviceberry	4	B TALL		MULIFSIE
AFA	Acor x freemans Fast Fantasy	Felf Fantasy Maple	8	2.5	888	
AFC.		Celebration Maple	5	2.5	BSB	
	Azer rubrum 'Karpick'	Karpick Red Maple	5	2.5	888	
CA	Cornus alternifolia	Pagoda Dogwood	5	P TALL		MULTISTE
CCJ	Carpinus caroliniana 'JN Strain'	JN Strain Musclewood	5	B TALL		MULTI-STE
CCN	Cercis canadensis Nonhern Strain	Northern Strain Redbud	4	8 TALL	BAB	MULTISTE
COLL	Ceitis occidentalis 'Ulzam'	Utra Hisckberry	6	25	BSB	
GBA	Girkga biloba 'Autumn Gold'	Autumn Gold Girkgo	3	25	848	
COE	Girkgo biloba 'Princeton Sentry'	Princeton Sentry Ginkgo	6	2.5	B&B	
GTC	Gleditala triacanthos 'Shademaster'	Shademaster Honeylocust	7	26	BAB	
Unc	Makes 'Praide Fire'	Prairie Fire Crabappie	В	B' TALL	838	MULTISTE
	Nyssa sylvatica 'Widfre'	Wildfire Black Gum	4	2.5	88B	
	Ostrya wiginana	rentwood	8	8 TALL	B&B	MALTISTE
	Syringa resculata 'kory Pillas'	Nory Piter Japanese Tree Lifac	5	1.5	848	
SHU	GREEN TREES	Red) au aque no live				
	Abies concolor	Concolor Fir	7 7	8 TALL	BAB	1
		Riack Hills Scruce	12	8 TALL	BAB	1
	Picea glauca var. denseta	Fastern White Pine	4	8 TALL	888	1
PS	Pinks strobus	Castell Mister of	·			
DECIL	DUOUS SHRUBS	Vicuos Beauty Chokeberry	5	38 TALL	POT	1
AM	Arona melanocarpa 'iriquo's Beauty'		11	36 TALL		
CSA	Comun serices 'Arctic Fire'	Arctic Fire Dogwood	17	18" TALL		
FGB	Fotherpita gardenii 'Beaver Creek'	Beaver Creek Fothergia	9	24" TALL		
HMA	Hydrangea macrophylla 'All Summer Beauty	All Summer Beauty Hydrangea	8	36' TALL		+
POS	Physocarpus opulions Seward	Summer Wine Ninebark	31			
RT		Staghorn sumac				
SJM	Spraea japonica 'Magic Carpet'	Magic Cerpet Spiraea	20			-
ŞP	Syringa 'Penda'	Bidomerang Lifac	10			
	Viburrum cariesii	Koreanspice Viburnum	10			
VT	Viburnum trikobum 'Afredo'	Alfreado Cranberrybush Viburnum	7	48' TALL		
WR	Weigela 'Rumba'	Rumba Weigela	11	24 TALL	POT	
	RGREEN SHRUBS					
CPG	Chamaecyparis pisifera 'Golden Mops'	Golden Mops False Cypress	18			
11-153	Juniperus horizontalis 'Blue Chip'	Blue Chip Juniper	9			
ISM	Juniperus scopulorum Welchi'	Welch Juriper	6	24" TALL		
0.0	Juniperus virginiana Blue Mountairi	Baue Mountain Juniper	17			
RP		PJM Rhododendron	7	36T TALL		
	Tsuga canadensis 'Bermer'	Bennet Dward Canadian Hemioci	21			
777	Taus x meda Tauntoni	Taunton Yew	23			
700	1 Thuis occidenta's 'Homstrup'	Homstrup Arborytae	4	24" TAL		
101	Their providentals 'Smarand'	Pyramidal Arborylas	29	48" TALL	B&B	****



ELAN APARTMENTS

DATE: 04-01-15

DR HIN BY: MS FN: 14-03-104

1) of the specific to be It to so be be to be to be to be to be to to to to to to be to to to be **BUILDING 'B1'** 3 STORIES 1.7 1.6 52 UNITS 5 : 1 : 1.2 1.s 1 22 20 **BUILDING 'A1'** 1. 1. 1. 90 OC 1. 1. 1. 1. 1. 1. 1. 3 STORIES 44 UNITS **BUILDING 'B2' 3 STORIES** 10 10 56 UNITS t. 1.c to be

Lumin	alre Sche	dulo				
Qty	Label	Arrangement	Total Lamp Lumens	Lum. Lumens	LLF	Description
16	OA23	SINGLE	14000	9612	0.750	LUMARK + PFT11523P15
3	OB3	SINGLE	NA.	2649	0.875	LUMARK + XTOR3A
17	ос	SINGLE	NA.	1209	0.940	LUMIERE + 303-B1-LEDB2-4000-UNV-T2-DIMELV-BZ-36

Calculation Summary							
Label	CalcType	Units	Avg	Max	Min	Avg/Min	Max/Min
ENTIRE SITE	Illuminance	Fc	0,55	15.5	0.0	NA.	NA.
PARKING LOT A DRIVES	Burninance	Fc	1,44	5.5	0.4	3.60	13.75



Enterprise Lighting LTD

QUARRY VISTA / ELAN RESIDENTIAL DEVELOPMENT FITCHBURG, WISCONSIN

SITE LIGHTING PLAN

APR. 15, 2015 1" = 30'-0" 5HECT NAMER E1



Date: Dec 10, 2014

Enterprise Lighting, LTD. 2007 Pewaukee Rd. Waukesha WI 53188 Phone: (262) 953-2700 Fax: (262) 953-2710

Job Name **Quarry Vista - current site**

> **Bid Date** Dec 10, 2014

Submittal Date Dec 10, 2014

Catalog Number: Type: Submitted by Enterprise Lighting, LTD. PFT11523P15 Job Name: **OA23** Quarry Vista - current site Notes:

(E) COOPER LIGHTING - LUMARK® ♣ columbre solutions



The Lumark Tribute Pole/Fixture Combo features all you need for easy selection and installation for poles and fixtures. Including the quality, die-cast Triubte area luminaire and 8" arm complete with lamp, square straight steel pole and necessary anchorage. Available in single or dual

The Tribute/Pole Combo is ideal for parking areas, access roadways and other general off street area/site lighting applications.

O-A-Invilla	Туре
Catalog #	
Project	
Comments	Date
Prepared by	

SPECIFICATION FEATURES

Construction

Enterprise Ligh

DESCRIPTION

Rugged one-piece die-cast aluminum housing and door frame finished in dark bronze polyester powder paint. One-piece silicone gasket protects the optical chamber from performance degrading contaminants. One (1) stainless spring latch and two (2) stainless steel hinges allow toolless opening and removal of door frame. U.L. Listed and CSA certified for wet locations.

Hydroformed anodized aluminum reflector offered in an adjustable Type II/III or a Type IV distribution. Optical modules are field rotatable in 90° increments and offered standard with medium or mogul-base lampholders.

Electrical

Ballast and related electrical componentry are hard mounted to die-cast housing for optimal heat transfer and operating efficiency.

Mounting

Extruded 8" aluminum arm features internal bolt guides for easy positioning of fixture during installation to pole.

Housing and arm finished in a 5 stage premium TGIC bronze polyester powder coat paint.

Shaft is one piece construction ASTM A500 grade "B" steel, shot blasted and finished in dark bronze polyester powder coat. Anchor base is fabricated from ASTM grade steel. ASTM A366 steel full base cover is provided to enclose base plate and anchor bolts. Anchor bolts are per ASTM A576 with (2) nuts, (2) flat washers, and (1) lock washer. Hardware and threaded portion of bolt are hot dip galvanized. 3" hook for 3/4" bolt. 4" hook for 1" bolt.

DARK SKY FCC

COMPLIANT



PFT TRIBUTE AND **POLE COMBO**

150 - 400 W **High Pressure Sodium Pulse Start Metal Halide**

> 15' - 30' Square Straight Steel Pole

POLE AND FIXTURE COMBO

TECHNICAL DATA (Fixture)


Hi-Reactance Ballast Input Watts

150W HPS HPF (190 Watts) 150W MP HPF (185 Watts) **CWA Ballast Input Watts** 250W MP HPF (283 Watts) (E) 250W HPS HPF (295 Watts)

U.L. Wet Location Listed CSA Certified EISA Compliant (E) **ENERGY DATA**

WATTAGE LAMP TYPE Pulse Start Metal Halide (MP) 150, 250, 320, 400W High Pressure Sodium (HP) 150, 250, 400W

DIMENSIONS

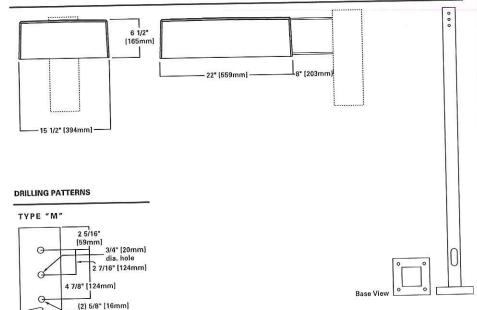



Effective Projected Area: (Sq. Ft.) Single: 1.62 Dual: 3.24

320W MP HPF (365 Watts) (E) 400W MP HPF (452 Watts) (E) 400W HPS HPF (465 Watts)


SHIPPING DATA Approximate Net Weight: 39 lbs. (17.73 kgs.)



COOPER Lighting www.cooperlighting.com

Specifications and Dimensions subject to change without notice.

Type: Submitted by Enterprise Lighting, LTD. Catalog Number: Job Name: PFT11523P15 **OA23** Quarry Vista - current site Notes: Enterprise Ligh

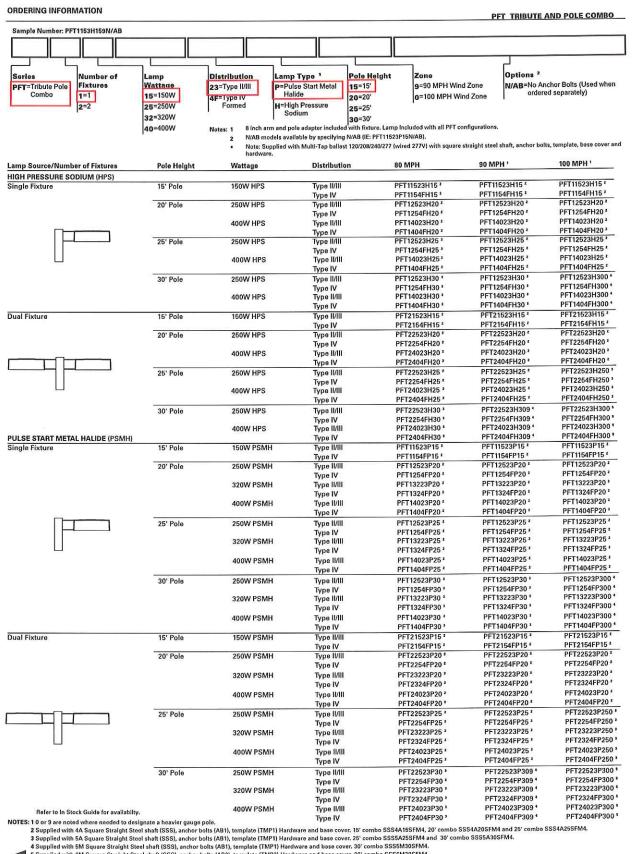

5 Supplied with 6M Square Straight Steel shaft (SSS), and

COOPER Lighting www.cooperlighting.com

Specifications and Dimensions subject to change without notice. Lumark • Customer First Center • 1121 Highway 74 South • Peachtree City, GA 30269 • TEL 770.486.4800 • FAX 770.486.4801 ADH082319 10/14/2009 12:33:28 PM

Submitted by Enterprise Lighting, LTD.

Job Name: Quarry Vista - current site Enterprise Ligh

Type III Formed

Catalog Number: PFT11523P15

Type IV


OA23

Гуре:

Notes:

PHOTOMETRICS (Complete IES files available at www.cooperlighting.com)

Type III Formed

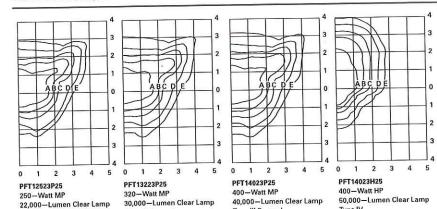

Type III Formed

nting height and read across fo footcandle values of each isofootcandle line. Distance in units of mounting height. Footcandle Values for Isofootcandle Lines Height A B C D E
3.00 1.50 0.75 0.30 0.15
2.00 1.00 0.50 0.20 0.10

1.38 1.69 0.34 0.13 0.06



Specifications and Dimensions subject to change without notice.

ADH082319 10/14/2009 12:33:28 PM

Lumark • Customer First Center • 1121 Highway 74 South • Peachtree City, GA 30269 • TEL 770.486.4800 • FAX 770.486.4801

Submitted by Enterprise Lighting, LTD.

Job Name: Quarry Vista - current site Enterprise Ligh

Catalog Number:

XTOR3A

Type: OB3

Notes:

DESCRIPTION

The patent pending Lumark Crosstour™ LED Wall Pack Series of luminaries provides an architectural style with super bright, energy efficient LEDs. The low-profile, rugged die-cast aluminum construction, universal back box, stainless steel hardware along with a sealed and gasketed optical compartment make the Crosstour impervious to contaminants. The Crosstour wall luminaire is ideal for wall/surface. inverted mount for façade/canopy illumination, post/bollard, site lighting, floodlight and low level pathway illumination including stairs. Typical applications include building entrances, multi-use facilities, apartment buildings, institutions, schools, stairways and loading docks.

	LUMARK® energy
Catalog #	Туре
Project	
Comments	Date
Prepared by	

SPECIFICATION FEATURES

Construction

Slim, low-profile LED design with rugged one-piece, die-cast aluminum hinged removable door and back box. Matching housing styles incorporate both a small and large design. The small housing is available in 10W and 20W. The large housing is available in the 30W model. Patent pending secure lock hinge feature allows for safe and easy tool-less electrical connections with the supplied push-in connectors. Back box includes three (3) half-inch, NPT threaded conduit entry points. The universal back box supports both the small and large forms and mounts to standard 3-1/2" to 4" round and octagonal, 4" square, single gang and masonry junction boxes. Key hole gasket allows for adaptation to junction box or wall. External fin design extracts heat from the fixture surface. Onepiece silicone gasket seals door and back box. Minimum 5" wide pole for site lighting application. Not recommended for car wash applications.

Silicone sealed optical LED chamber incorporates a custom engineered mirrored anodized reflector providing high-efficiency illumination. Optical assembly includes impact-resistant tempered glass and meets IESNA requirements for full cutoff compliance. Solid state LED Crosstour luminaries are thermally optimized with five (5) lumen packages in cool 5000K or neutral warm 3500K LED color temperature (CCT).

Electrical

LED driver is mounted to the die-cast housing for optimal heat sinking. LED thermal management system incorporates both conduction and natural convection to transfer heat rapidly away from the LED source. 10W models operate in -40°C to 40°C [-40°F to 104°F]. 20W and 30W models operate in -30°C to 40°C [-22°F to 104°F]. High ambient 50°C models available. Crosstour luminaires maintain greater than 70% of initial

light output after 72,000 hours of operation, Three (3) half-inch NPT threaded conduit entry points allow for thru-branch wiring. Back box is an authorized electrical wiring compartment. Integral LED electronic driver incorporates surge protection. 120-277V 50/60Hz or 347V 60Hz models

Finish

Crosstour is protected with a Super durable TGIC carbon bronze or summit white polvester powder coat paint. Super durable TGIC powder coat paint finishes withstand extreme climate conditions while providing optimal color and gloss retention of the installed life.

Warranty


Five-year limited warranty.




XTOR CROSSTOUR LED

APPLICATIONS: WALL / SURFACE POST / BOLLARD LOW LEVEL FLOODLIGHT INVERTED SITE LIGHTING

DIMENSIONS

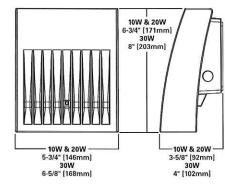

ESCUTCHEON PLATES

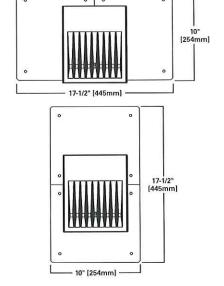

CERTIFICATION DATA

UL/cUL Wet Location Listed LM79 / LM80 Compliant **ROHS Compliant** ARRA Compliant ADA Compliant NOM Compliant Models IP66 Ingressed Protection Rated Lighting Facts® Registered DesignLights Consortium® Qualified* Title 24 Compliant

TECHNICAL DATA 40°C Maximum Ambient Temperature

External Supply Wiring 90°C Minimum

Effective Projected Area: (Sq. Ft.) XTOR1A/XT0R2A=0.34 XTOR3A = 0.45

SHIPPING DATA: 3.7 - 5.25 lbs. [1.7 - 2.4 kgs.]

Cooper Lighting by FAT-N

*www.designlights.org

2013-09-27 13:51:17

ADH111091

Submitted by Enterprise Lighting, LTD.

LUMEN MAINTENANCE

TM-21 Lumen

(72,000 Hours)

> 91%

> 91%

> 91%

> 91%

> 90%

> 90%

> 91%

> 91%

> 90%



Ambient

Temperatur

10W Model

25°C

40°C

50°C

20W Model

25°C

40°C

50°C

25°C

40°C

50°C

30W Model

Job Name: Quarry Vista - current site

Theoretical L70

> 350,000

> 340,000

> 330,000

> 340,000

> 320.000

> 300,000

> 340,000

> 320,000

> 300,000

LUMENS - CRI/CCT TABLE

Catalog Number: XTOR3A

Notes:

Type: OB3

XTOR CROSSTOUR LED

CURRENT DRAW

LED Information	XTOR1A	XTOR2A	XTOR2A-N	XTOR3A	XTOR3A-N	Voltage	
Delivered Lumens	200	4400	1323	2649	2273	Voltage	1
(Wall Mount)	734	1432	1323	2049	2213	120V	0
Delivered Lumens (With Flood	713	1424	1315	2614	2243	208V	0
Accessory Kit)	710	1121	19.14		13000000	240V	0
B.U.G. Rating*	B1-U0-G0	B1-U0-G0	B1-U0-G0	B1-U0-G0	B1-U0-G0	277V	0
CCT (Kelvin)	5000	5000	3500	5000	3500	347V	0
CRI (Color Rendering Index)	67	65	68	65	68		
Power Consumption (Watts)	8W	21W	21W	30W	30W		

1200235000	Model Series				
Voltage	10W	20W	30W		
120V	0.06A	0.21A	0.29A		
208V	0.04A	0.13A	0.18A		
240V	0.04A	0.12A	0.16A		
277V	0.03A	0.10A	0.14A		
347V	0.03A	0.08A	0.11A		

ORDERING INFORMATION

Sample Number: XTOR2A-N-WT-PC1

Series 1	LED Kelvin Color ²	Housing Color	Options (Add as Suffix)	Accessories (Order Separately)
XTOR1A=Small Door, 10W		[Blank]=Carbon Bronze (Standard) WT=Summit White	PC2=Photocontrol 208-277V 3.4 HA=50 C High Ambient 5	WG/XTOR=Wire Guard * XTORFLD-KNC=Knuckle Floodlight Kit ⁷ XTORFLD-TRN=Trunnion Floodlight Kit ⁷ XTORFLD-KNC-WT=Knuckle Floodlight Kit, White ⁷ XTORFLD-TRN-WT=Trunnion Floodlight Kit, White ⁷

models. 5 Thru-branch wiring not available with HA option or with 347V. 6 Wire guard for wall/surface mount. Not for use with floodlight kit accessory. 7 Floodlight kit accessory supplied with knuckle (KNC) or trunnion (TRN) base, small and large top visors and small and large impact shield

STOCK ORDERING INFORMATION

10W Series	20W Series	30W Series
XTOR1A=10W, 5000K, Carbon Bronze	XTOR2A=20W, 5000K, Carbon Bronze	XTOR3A=30W, 5000K, Carbon Bronze
XTOR1A-WT=10W, 5000K, Summit White	XTOR2A-N=20W, 3500K, Carbon Bronze	XTOR3A-N=30W, 3500K, Carbon Bronze
XTOR1A-PC1=10W, 5000K, 120V PC, Carbon Bronze	XTOR2A-WT=20W, Summit White	XTOR3A-WT=30W, Summit White
ATOMIA-1 CI - 1011, SSCOR, 1201 1 G, Gallion Stories	XTOR2A-PC1=20W, 120V PC, Carbon Bronze	XTOR3A-PC1=30W, 120V PC, Carbon Bronze



5-DAY QUICK SHIP ORDERING INFORMATION

10W Series	20W Series	30W Series
XTOR1A-WT-PC1=10W, 5000K, Summit White, 120V PC	XTOR2A-PC2=20W, 5000K, 208-277V PC, Carbon Bronze	XTOR3A-PC2=30W, 5000K, 208-277V PC, Carbon Bronze
ATOMIA TITTO I INTO I I	XTOR2A-WT-PC1=20W, 5000K, Summit White, 120V PC	XTOR3A-WT-PC1=30W, 5000K, Summit White, 120V PC
	XTOR2A-WT-PC2=20W, 5000K, Summit White, 208-277V PC	XTOR3A-WT-PC2=30W, 5000K, Summit White, 208-277V PC
	XTOR2A-N-WT=20W, 3500K, Summit White	XTOR3A-N-WT=30W, 3500K, Summit White
	XTOR2A-N-PC1=20W, 3500K, 120V PC, Carbon Bronze	XTOR3A-N-PC1=30W, 3500K, 120V PC, Carbon Bronze
	XTOR2A-N-PC2=20W, 3500K, 208-277V PC, Carbon Bronze	XTOR3A-N-PC2=30W, 3500K, 208-277V PC, Carbon Bronze
6	XTOR2A-N-WHT-PC1=20W, 3500K, Summit White, 120V PC	XTOR3A-N-WHT-PC1=30W, 3500K, Summit White, 120V PC
	XTOR2A-N-WT-PC2=20W, 3500K, Summit White, 208-277V PC	XTOR3A-N-WT-PC2=30W, 3500K, Summit White, 208-277V PC

Cooper Lighting by FATON

1000 Eaton Boulevard Cleveland, OH 44122 United States Faton.com

Eaton's Cooper Lighting Busines 1121 Highway 74 South Peachtree City, GA 30269 P: 770-486-4800 www.cooperlighting.com

ADH111091 2013-09-27 13:51:17 Submitted by Enterprise Lighting, LTD.



Job Name:

Quarry Vista - current site

Catalog Number:

303-B1-LEDB2-4000-UNV-T2-**DIMELV-BZ-36** Notes:

Type: OC

lumière

DESCRIPTION

Eon 303 - B1 and 303 - B2 are compact, low profile, dimmable, LED bollards that provide downlight only via a fixed head. 303 - B1 has a single head on one side of the luminaire and 303 - B2 has two, integrated heads coming off opposite sides of the luminaire. 303 - B1 and 303 - B2 come standard with universal input LED drivers (120 -277V, 50/60 Hz). Dimming is achieved with a standard ELV, reverse phase dimming driver. Eon fixtures may be used indoors or outdoors and carry an IP66 rating. Our patented LumaLevelTM leveling system provides quick installation, easy adjustment, secure mounting and protection from vibration.

	Туре
Catalog #	
Project	
Comments	Date
Prepared by	

SPECIFICATION FEATURES

A ... Material

Head is precision-machined from corrosion-resistant 6061-T6 aluminum. Body is extruded aluminum and mounting base is cast from corrosion resistant silicone aluminum alloy.

B ... Finish

Fixture and mounting base are double protected by a RoHS compliant chemical film undercoating and polyester powdercoat paint finish, surpassing the rigorous demands of the outdoor environment. Mounting base is painted black. Fixture housing and head are available in a variety of standard colors. In addition to the standard five colors offered by Lumiere, the Eon bollards are also available in colors to match other outdoor Cooper brands, such as Invue. See the Finish section in the ordering detail for more information.

303-B1

COOPER Lighting

www.cooperlighting.com

C ... Lens

Clear, tempered glass lens, factory sealed with high temperature adhesive to prevent water intrusion and breakage due to thermal shock. EDGE LIT option: when specified with the EDGE option, the glass will be slightly thicker, clear, tempered and sealed in the same manner referenced above. The added glass thickness will offer a brigher line of light around the edge of the glass that will accentuate the fixture's aesthetics and styling.

D ... Adjustable Mounting Base

Cast aluminum mounting base is equipped with the patented Luma-LevelTM leveling system that includes mounting chassis, 70 shore neoprene base, stainless steel hardware and 3/4" conduit entry. It provides quick installation, easy adjustment, secure mounting and protection from vibra-

Stainless steel hardware is standard to provide maximum corrosionresistance.

F ... Electrical

Both models come standard with universal input LED drivers (120-277, 50/60Hz). The standard driver is ELV

LEDs are included and available in three color temperatures (2700K, 3000K & 4000K) and a variety of optics. Both color temperature and distribution must be specified when ordering - see reverse side for details and catalog logic. 303 - B1 comes standard with two mini lightbars and 303 - B2 comes standard with four mini lightbars.

H ... Labels & Approvals

UL and cUL listed, standard wet label. IP66 rated.

I ... Warranty

303-B2

Specification and Dimensions subject to change without notice.

Lumiere warrants it's fixtures against defects in materials & workmanship for five (5) years. Auxiliary equipment such as transformers, ballasts and LED drivers carry the original manufacturer's warranty

303-B1 / 303-B2

15.5 W LED 31 W LED

LED

BOLLARD

IP66

1.40° 35mm 1.40* 35mm 36.00" 5.47* 3.43⁻ 87mm 3.43* 87mm

Enterprise Ligh

Submitted by Enterprise Lighting, LTD.

Job Name:

Catalog Number: 303-B1-LEDB2-4000-UNV-T2-Quarry Vista - current site DIMELV-BZ-36 Notes:

Type: OC


LED INFORMATION

LED	Watts	Distribution	Total Lumens	CRI	°K	Life (hrs.)	Volts
LED	15.5	Type II - Lateral Throw	725	95	2700	50000	Universal Input (120 - 277V, 50/60Hz)
LEDB2 - 2700 - T2	15.5	Type IV - Forward Throw	709	85	2700	50000	Universal Input (120 - 277V, 50/60Hz)
LEDB2 - 2700 - T4	15.5	Type V - Flood	626	65	2700	50000	Universal Input (120 - 277V, 50/60Hz)
LEDB2 - 2700 - T5X	15.5	Type II - Lateral Throw	0.20	95	3000	50000	Universal Input (120 - 277V, 50/60Hz)
LEDB2 - 3000 - T2	15.5	Type IV - Forward Throw		85	3000	50000	Universal Input (120 - 277V, 50/60Hz)
LEDB2 - 3000 - T4	15.5	Type V - Flood		65	3000	50000	Universal Input (120 - 277V, 50/60Hz)
LEDB2 - 3000 - T5X	15.5	Type II - Lateral Throw	1209	95	4000	50000	Universal Input (120 - 277V, 50/60Hz)
LEDB2 - 4000 - T2	15.5	Type IV - Forward Throw	1181	85	4000	50000	Universal Input (120 - 277V, 50/60Hz)
LEDB2 - 4000 - T4		Type V - Flood	1044	65	4000	50000	Universal Input (120 - 277V, 50/60Hz)
LEDB2 - 4000 - T5X	15.5 31	Type II - Lateral Throw	1436	95	2700	50000	Universal Input (120 - 277V, 50/60Hz)
LEDB4 - 2700 - T2	31	Type IV - Forward Throw	1410	85	2700	50000	Universal Input (120 - 277V, 50/60Hz)
LEDB4 - 2700 - T4	31	Type V - Flood	1247	65	2700	50000	Universal Input (120 - 277V, 50/60Hz
LEDB4 - 2700 - T5X		Type II - Lateral Throw	12-17	95	3000	50000	Universal Input (120 - 277V, 50/60Hz
LEDB4 - 3000 - T2	31	Type IV - Forward Throw		85	3000	50000	Universal Input (120 - 277V, 50/60Hz
LEDB4 - 3000 - T4	31	Type V - Flood		65	3000	50000	Universal Input (120 - 277V, 50/60Hz
LEDB4 - 3000 - T5X	31	0.00	2393	95	4000	50000	Universal Input (120 - 277V, 50/60Hz
LEDB4 - 4000 - T2	31	Type II - Lateral Throw	2350	85	4000	50000	Universal Input (120 - 277V, 50/60Hz
LEDB4 - 4000 - T4	31	Type IV - Forward Throw	2078	65	4000	50000	Universal Input (120 - 277V, 50/60Hz)
LEDB4 - 4000 - T5X	31	Type V - Flood	20/8	65	4000	50500	S.II. S.IV. I. P. 1 (124 - 117)

NOTES AND FORUMULAS

- Apply appropriate light loss factors where necessary.
- Photometry is LM-79 compliant.

ORDERING INFORMATION

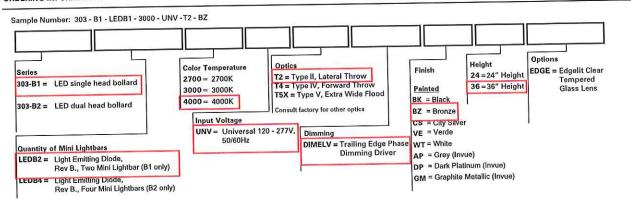

COOPER Lighting ww.cooperlighting.com Specification and Dimensions subject to change without notice.

Consult your representative for additional options and finishes.

Μ.	ASTE	RPL	AN D	ATA							
DC				UNI	ΓS				PAF	RKING	
3 1	ST	1 B R	1 BR+	2BR	2 B R +	TOTAL	BR'S	COVERED	SURFACE	TOTAL	RATIO
A 1	3	15	9	14	3	44	5 8	44	26	70	1.59/UNIT
B 1	3	17	13	16	3	5 2	68	5 2	32	8 4	1.62/UNIT
B 2	4	19	15	15	3	5 6	70	5 3	31	8 4	1.50/UNIT
т.	10	51	3 7	45	9	152	196	149	89	238	1.57/UNIT
	6%	34%	24%	30%	6%			1	1		1.21/BR

PARKING NOTES:

COVERED VEHICULAR & BICYCLE PARKING COUNTS ARE MINIMUM. SURFACE PARKING COUNTS ARE MAXIMUM. COVERED BICYCLE PARKING SHALL BE PROVIDED IN THE LOWER LEVEL BY INDIVIDUAL STORAGE LOCKERS OR WALL/CEILING HOOKS ABOVE AUTOMOBILE SPACES.

LANDSCAPING NOTES:

ALL LANDSCAPING ELEMENTS SHOWN ON THIS MASTERPLAN ARE CONCEPTUAL ONLY. SEE LANDSCAPE PLANS FOR INFORMATION AND DETAILS REGARDING THE ACTUAL LANDSCAPING FOR THIS PROJECT.

EXTERIOR SITE LIGHTING:

ALL EXTERIOR LIGHTING SHALL BE ESTABLISHED, DIRECTED, AND MAINTAINED SO AS NOT TO BE CAST DIRECTLY ON PUBLIC RIGHTS-OF-WAY OR NEIGHBORING PROPERTIES-- OR BE LIGHTED IN INTENSITY OR COLORS SERIOUSLY DISTURBING TO NEIGHBORING PROPERTIES (PER CITY OF FITCHBURG ZONING CODE SECTION 22-607 (B)10.)


SEE THE FOLLOWING SHEETS FOR ADDITIONAL SITE INFORMATION:

SHEET ASP101-A1

BUILDING 'A1'

SHEET ASPIOL-B1 SHEET ASPIOL-B2 BUILDING 'BI' Building '82'

ZONING REQUIREMENT	DESIGN VALUE	CALCULATIONS
SITE DENSITY	31.40 Units/Acre	152 Units / 4.84 AC. = 31.40
BUILDING COVERAGE	29.6% of Parcel	62,321 S.F. / 210,871 S.F. = 29.6%
FLOOR AREA RATIO	83.4% of Parcel	175,887 S.F. / 210,871 S.F. = 83.4%
IMPERVIOUS SURFACE	57.1% of Parcel	120,350 S.F. / 210,871 S.F. = 57.1%
LANDSCAPE AREA	42.9% of Parcel	90,521 S.F. / 210,871 S.F. = 42.9%

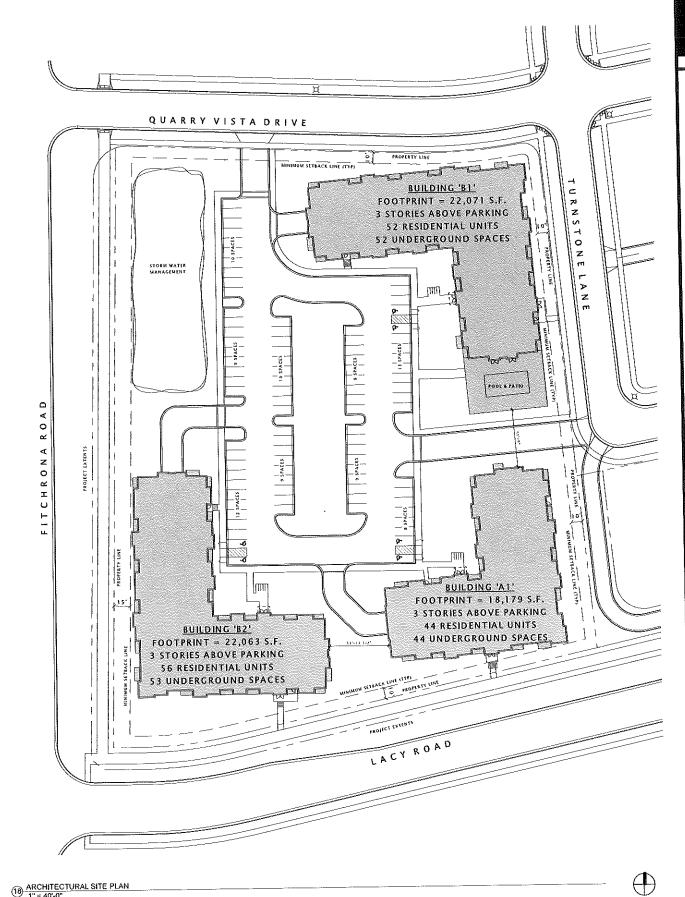





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PROGRESS DOCUMENTS

These documents reflect progress and intent and may be subject to change, including additional detail. Their are not final construction documents and should not be used for final bidding or construction-related purposes.

DATE OF ISSUANCE APRIL 21, 2015

REVISION SCHEDULE

Mark Description Date

SHEET TITLE

ARCHITECTURAL SITE PLAN - OVERALL

SHEET NUMBE

ASP100



ELAN RESIDENTIAL DEVELOPMENT Fitchrona & Lacy Rd. Fitchburg, Wisconsin





SPECIFIC IMPLEMENTATION PLAN

BUILDING: A1

PROGRESS DOCUMENTS


hese documents reflect progress and intent and may e subject to change, including additional detail. These re not final construction documents and should not be sed for final bidding or construction-related purposes.



JLA PROJECT NUMBER:

14-0515

APRIL 21, 2015

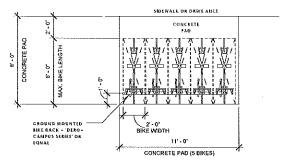


EXTERIOR BIKE PARKING
1/4" = 1'-0"



EXAMPLE OF THE STYLE OF NIKE RACK TO BE LOCATED AT THE EXTERIOR OF EACH BUILDING

EXTERIOR BIKE RACK STYLE

1/8" = 1'-0"

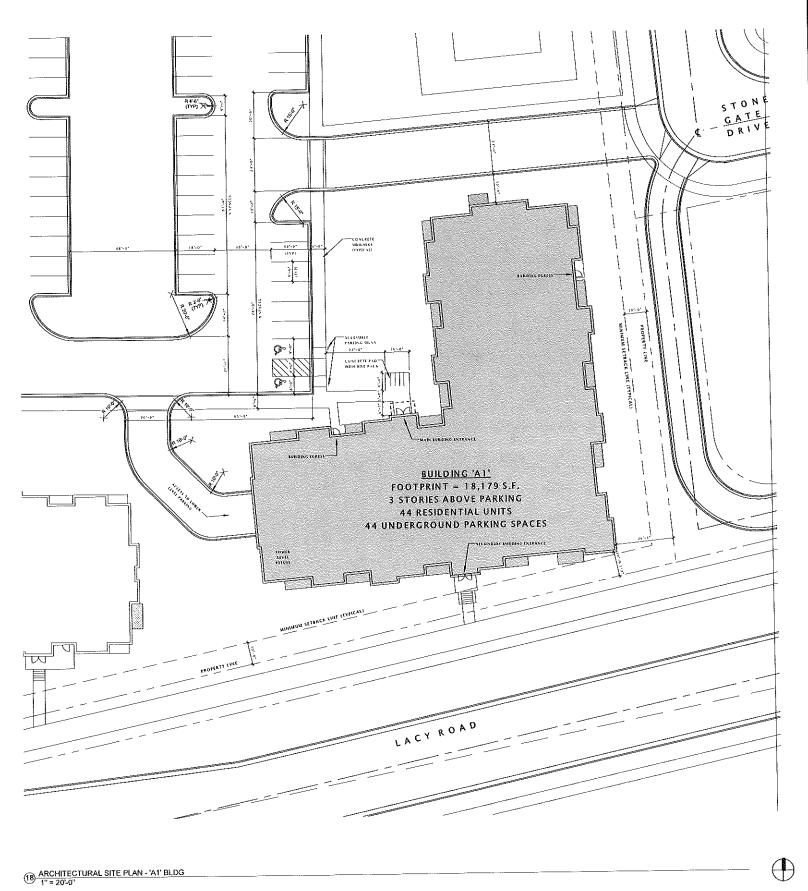





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REVISION SCHEDULE


Maik Description Oxte

SHEET TITLE

ARCHITECTURAL SITE PLAN - BUILDING 'A1'

SHEET NUMBE

ASP101-A1

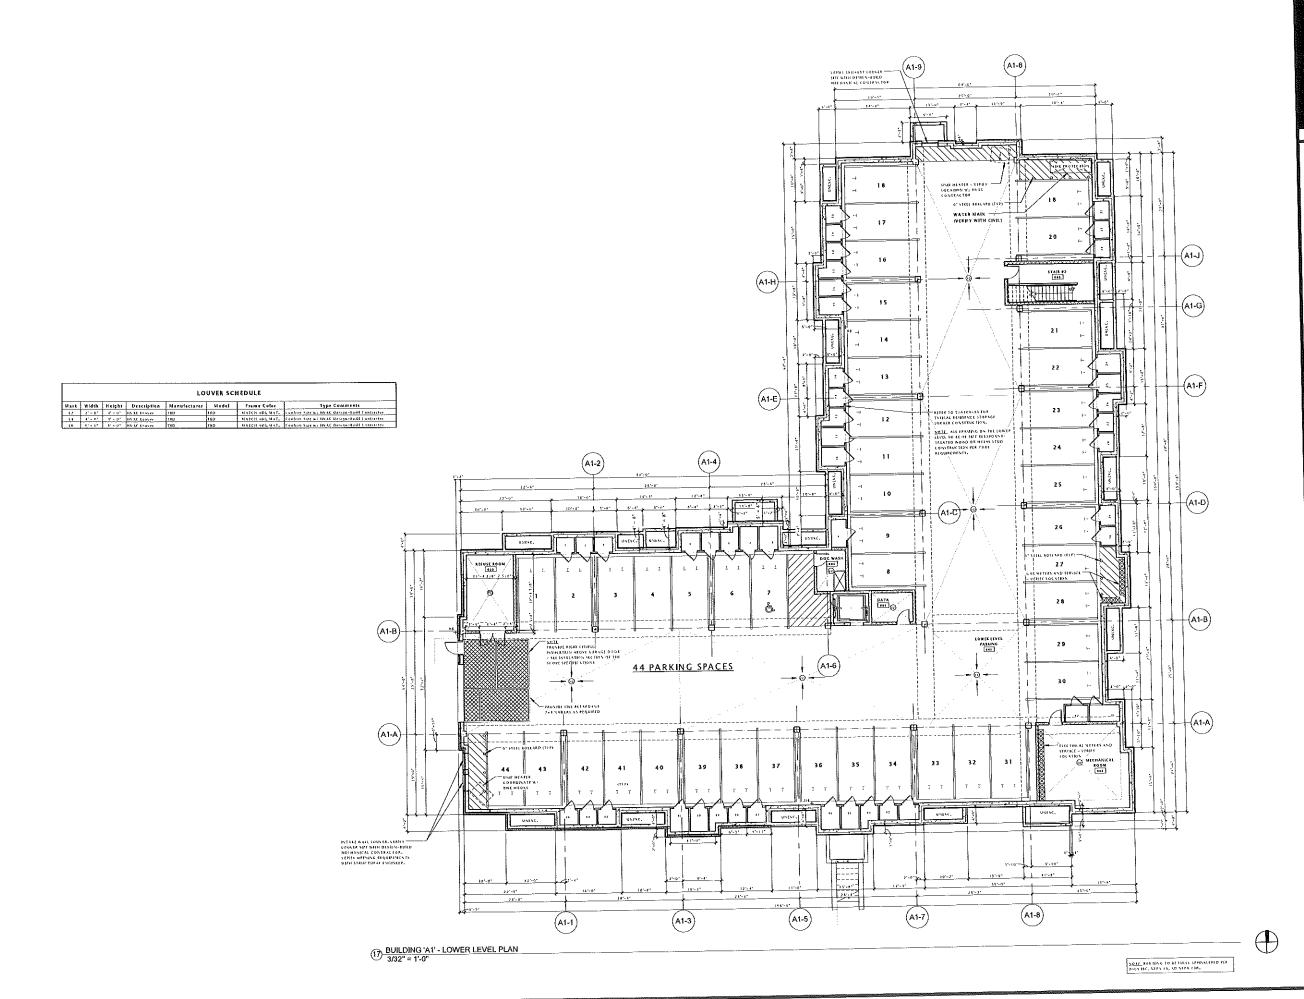



JLA PROJECT NUMBER: 14-051



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DATE OF ISSUANCE APRIL 21, 2015
REVISION SCHEDULE

SHEET TITLE

BUILDING 'A1' LOWER LEVEL PLAN

SHEET NUMBER


A100-A1

	MINDOM SCHEDALE										
Mark	Width	Helabi	Description	Manufacturer	Model	Window Fizme Color	ENERGY AT	SHGC	DLO AREA	VERT AREA	Type Comments
,	1 9.	67 - 07	Singl Single Hang + Single	Photon Westons and Directs	1-64 5-0H	WHITE	9.32	11,78	15.9.55	271-29	bild Pattern As Shown
9	3" - 4"	6" - 4"	Vint fingle Hang - hinole	FAGER BINTORS AND CHOIS	3-4-6-0H	WHITE	9.32	0.28	15.2 56	7.9.55	Lord Pattern 35 Shown
£	5" - 19"	6" - 11"	Yingh Single Hang - Twis	Physical Mindows and business	2-69 TWIN 6-198	WHITE	9.32	21.0	22,4 57	£1.4 \$£	Gerl Pattern Ar Shopp
- 0	E' - 19*	5" - 4"	Vinyl Single Hang - Twin	Photon Windows and Ocers	5-1-8 TW15 6-1-91	WHITE	9.33	0.24	78.1.51	11,137	Gord Pattern As Shown
7	4' + 9"	6"+ 11"	Vinst Vinate Hang + Triple	Physica Stratoms and Goors	S-I'M TEIPLE 5-RM	WHITE	9.33	0,21	113.11	21,8 51	Girk Partein As Shawa
10	\$1.45	E 14.	Single Farnch Dave - Hinged	FigGers Windows and Doubt	1-1% 6-10H	WHELE	0,13	0.21	11,5 57	18,9 51	Na Godes
G	5 9.	1' - "	hing hande tions - feret	\$8,6em Windows and Dours	2-3% LOOH FIFTURE	WHITE	-1,15	0.28	7,7 \$1	0.0 58	Grid Facters As Shown
1	\$" - u*	6" - 10"	Z-Panel Sign Sichna Passa Daoi	Chicago Windows and Doors	5-6W 6-TUH	WHITE	0.29	11,39	91.5 16	17,048	Sa Crites

	LOUVER SCHEDULE							
Mark	Width	Height	Description	Manufacturer	Model	Frame Color	Type Comments	
Ež	2" + 9"	4" + 9"	HV3C Couver	110	TED	MATERIADE MAT.	Cumfain Size w/ HVAC Beingn-Build Contractor	
1.4	41 / 107	4" - 0"	HUAC COWSEL	TED	TBD	MATCH ADL MAT.	Contum Size wi HVAC Design Suit Contractor	
	43 AT	21 mg	DECEMBER 1	r.s.n.	F-00	48 5 74 15 5 5 5 14 5 7	C. C. C. HUNGER C. C. C. Land C. C. C. C.	

-	IILDING A1 -		EN	LARGED UNIT SHEET LISTIN
	OR UNIT SCH	EDUEE	SHEET	PLAN TYPES
UNIT No.	PLAN TYPE	AREA	A410	A1,AL3,AIM,AL3M,A2
	PLAN C2	BS O SF	A411	\$1,61,1,61,2, \$1M,\$1.TM,\$1.2M
11	PLAN C2M	75.2 SF	A412	NIA, NI.SA, DI.JA
13	PLAN DIM	1173 SF	A413	82.82M
4	PLAN 01.1M	1148 SF	A414	C)
-	PLAN CT PLAN BILLM	75 2 5F	A435	C2, C2.1, C24, C2.3M
	PLAN EI	1307 55	A416	C3, C3,1, C3N, C3.)M
ô	PLAN BIA	729 55	A417	D1, 01.2, 01.4, 01.5, D1.6
2	PLAN 21	729 SF	A418	D114 D1 714 G1 314 G1 414
4	PLAN \$1,1M	752 SF	1 ^***	D1M, D1.1M, D1.3M, D1.4M, D1.5M, D1.6M
5	PLAN AT	574 58	- I	
6	PLAN D2M	1182 SF	A419	D2, D2,1, D2M, D2,1M
7	PLAN D2	11\$2 SF	A420	EL.ELD. ETM. ET.IM

w	INDOW NOTES:
١,	ALL MINDOWS AND PARED ODOPS SHALL BE VINTE WINDOWS. SEE
40	EFRICATIONS FOR WORF INFORMATION,
٠.	MINDOW SIZES ARE NOMEYAL - GENERAL CONTRACTOR TO YERRY ALL
R O	FUGIL OFENINGS WITH MANUFACTURERS SPECIFICATIONS.
1,	CONTRACTOR WAS PROVIDE ALTERNATE MINDOW MANUFACTURE?
W 1	TH DWNER AND ARCHITECT APPROVAL. ALTERNATE WINDOWS WHST
ŧq	URL SEFERITED WINDOWS IN QUARTES, PERFURMANCE, AND APPRARANCE
٠.	TEMPER ALL CLASS AS THE FOLLOWING LOCATIONS
	-Within 21' FROM DODAS
	-Within 15, thun trained stout
	HN ALL DOUBS
	-ASOVE TUB ENCLUSURES.

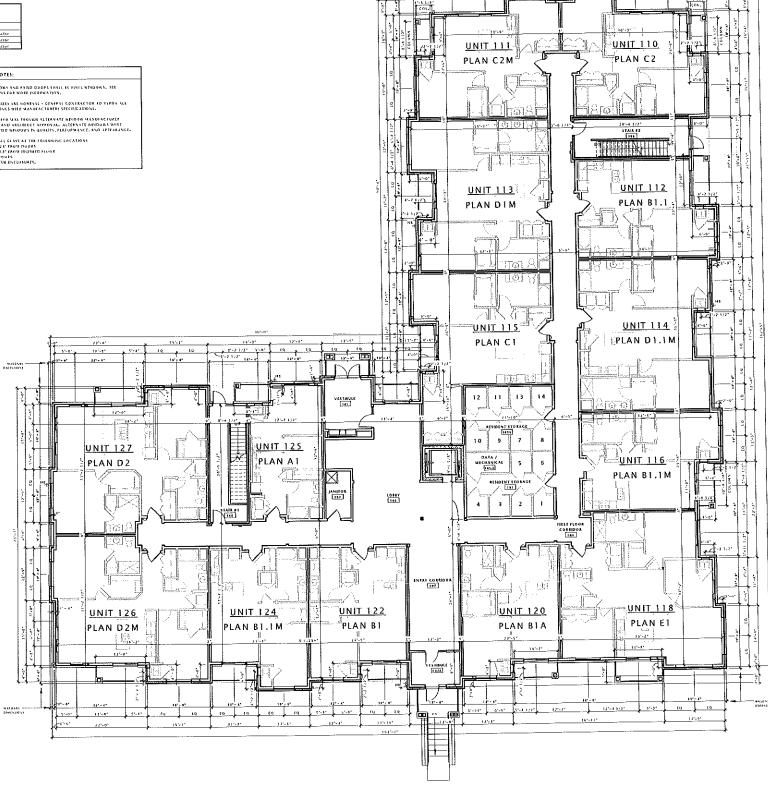

JOSEPH LEE ASSOCIATES

JLA PROJECT NUMBER:



FIDUCIARY REAL ESTATE DEVELOPMENT, INC.

SPECIFIC IMPLEMENTATION PLAN



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ELAN RESIDENTIAL DEVELOPMENT

PROGRESS DOCUMENTS

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ATE OF ISSUANCE APRIL 21, 2015

REVISION SCHEDULE

Description

BUILDING 'A1' FIRST FLOOR PLAN

A101-A1

DUILDING 'A1' - FIRST FLOOR PLAN
3/32" = 1'-0"

NOTE BUILDING TO BE FULLY SPRINKLERED FOR 2009 BY. SEPR 13, AD SEPR 138.


	WINDOW SCHEDULE										
Mark	Wilsish	Height	Description	Manufacturer	Model	Window Frame Color	ENERGY AN	SHGC	DLO AREA	VENT AREA	Type Comments
A	V + 22	6, - 0,	benyl Smyle Hung - Single	Ft, Cen Windows and Done	1 - C-12 - 0 - 14 H	WHITE	9,17	9.73	11.0 51		Grid Pattern 3x Shown
1	3' - 4'	6,-0,	Yangl Snayle Hang - Single	Micen Wordows and Doors	3-0% £-0H	WHITE	4.37	45.0	15,2 55		Ceral Particen da Shown
ζ.	5'	4 4.	Vanyl Sargle Hung - Teau	Phicem Wattons and Dours	r-Ap then A-on	WHILE	0.17	0,28	27.151		Cerd Pattern &c Showll
0	6'-1'	5' - I**	Vinyl Siggle Hone - Lwig	Philips Wendows and Coasts	3+016 TWPN 5-011	35,4515 F	17.0	0.28	22,231		Cold Pattern 43 Shown
	11. 4.	0'-11"	Vincil Single Hung - Triple	Physical Windows and Guars	BARW TRIFLE SARII	m.HITE	0.17	0.23	41,734		Gird Pattern to them
60	3 - 19	6' - 10'	Signale French Dani - Hinged	Fl.Cers dindons and Bones	1-1/y 6- DM	WHITE	0,33	3,25	11,5 51	18.934	Confides
- 6	2"-2"	4" - 11"	Vinci Signite Henry + Face4	Fl. Cem Windows and Boars	2-3W 4-OFF PR TURE	GHITE	3.10	4.23	2.7 M	0.0.58	SHA PAHEN IS Shound
						The same	>4	4.70	11651	17.1 17	No. Cuittee

	LOUVER SCHEDULE							
Mark	Width	Keight	Description	Manufactujer	Madel	frame Color	Type Comments	
17	2'-0"	1,-0,	HEAT LOVET	110	160	UNICHADA MATA	Contem tier u. HV4C Design-Buill Contestion	
ę i	4' - a*	1'-0"	MEAC Laures	TED	TED	MATCH ADJ. WAT.	Confirm Vice to HVAL Design-Suils Contractor	
16	6' - 0"	5' - 0"	MVAC Labora	TRE	TED	MATCH ADL WAL.	Continu Sate wil HVAC Design - Suits Constactor	

FL	OOR UNIT SCH	EDULE
UNIT		1
NO.	PLAN TYPE	ARÇA
210	PLAN CZ.I	258
211	PLAN CZ.ISI	898
212	PLAN 81.1	752
213	PLAN O1.5M	1161
214	PLAN D1.3M	1156
215	PLAN CI	1011
716	PLAN 81.114	752
214	PLAN E1.1	1331
220	PLAN 81	729
222	FLAN D)	1173
223	PLAN AT.IM	752
224	PLAN 81.1M	752
225	FLAN AL.I	582
226	FLAN DZ.TM	1190
227	PLAN DZ.1	1190

EN	LARGED UNIT SHEET LISTING
SHEET	PLAN TYPES
A410	ALALI, ALM, ALIN, AZ
A411	81, 83.1, 81.7, 81M, 83.1M, 81.7M
A417	\$1A, \$1.1A, D1.1A
A413	12, B2M
A414	C1
A415	C2, C2.1, C2M, C2.1M
A416	C3, C3.1, C3M, C3.1M
A417	01.91.7,01.4,01.5,01.6
A418	D1M, D1.3M, D1.3M, D1.4M, D3.5M, D1.6M
A419	DZ, D2.1. D2M. D2.1M
4420	FL FLL FIN. FLAR

W E	DOW NOTES:
۱	LE MINDOWS AND PARIO UDDRS SHALL BE VINSE RINDOWS. SEE
SPE	HIGH ATIONS FOR MORE INFORMATION.
2.	ANDOW SIZES ARE NOWINAL - CENERAL CONTRACTOR TO VERHY SILE
RGI	IGH OFENINGS WITH STANUFAC TURERS SPECIFIC ATTOMS.
s	CONTRACTOR MAY PROVIDE ALTERNATE WINDOW MANUFACTURES
ĸп	NOWNER AND ARCHITECT APPROVAL, ALTERNATE HINDURS WUNT
TQ.	RESPECIFICO WINDOWS IN QUARTITY, PERFORMANCE, AND APPRAPANC
4,	TENFER ALL GLASS AT THE FOIL WAING COC ATTOMS
	-WINNIN ZAT FROM UDORS
	-WITHIN DAT FROM FINISHED FLOOR
	-IN ALL DOORS
	-ABONE TOR ENGLASURES.

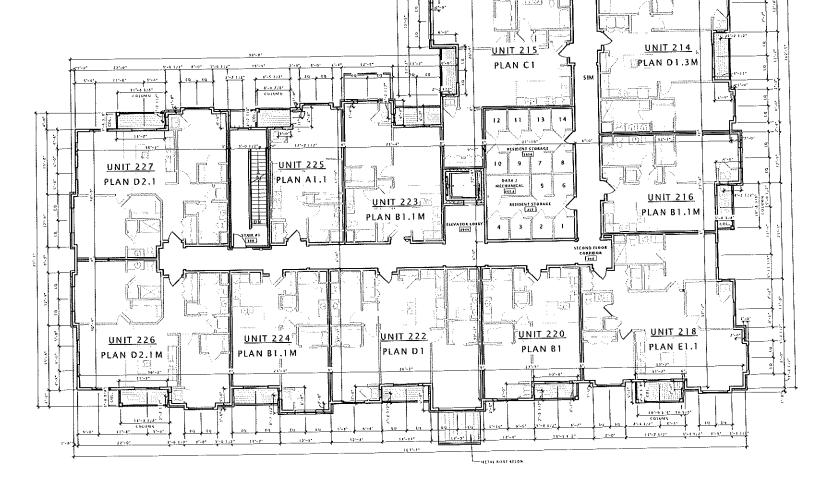

2,-0, 8,-0, 2,-4, Fd Ed

PLAN C2.1M

UNIT 213

PLAN D1.5M

<u>UNIT 210</u> =PLAN C2.1

STAIR #7

UNIT 212

PLAN B1.1

MOTE EUROPE, TO BE FULLY SPRINKERED PER 2009 ISC., NIPA 13. AD NEPA 138.





FIDUCIARY REAL ESTATE DEVELOPMENT, INC.

SPECIFIC IMPLEMENTATION PLAN



apartments

ELAN RESIDENTIAL DEVELOPMENT

PROGRESS DOCUMENTS

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APRIL 21, 2015 DATE OF ISSUANCE

REVISION SCHEDULE

BUILDING 'A1' SECOND FLOOR PLAN

SHEET NUMBER

A102-A1

8UILDING 'A1' - SECOND FLOOR PLAN
3/32" = 1'-0"




	LOUYER SCHEDULE								
Mark	Width	Height	Description	Manufacturer	Model	Frame Color	Type Comments		
Lz	2" - 0"	4'-0-	HVAC COULER	TER	180	матенаод мат.	Confirm Size w/ HC SC Design-Linds Contractor		
Le	4' 5 15"	4, . 0.	HVAC LEGGER	TED	120	MARCHADLMAI,	Canting Size 4 / HSAC Design-Ends Cuntractor		
16	6" = 0"	6" - 6"	HVAC Lewset	T#D	TBD	чатен лод мат.	Conduct Size to 1 Htt AC Design-Build Contractor		

В	GILDING A1 - 1	CHIRD
FL	OOR UNIT SCH	EDULE
UNIT		
NO.	PLAN TYPE	AREA
	r	
310	PLAN CZ,I	858
111	PLAN CZ, IN	858
312	PLAN BY. I	752
313	PLAN D1.6M	1181
314	FLAN D1.3M	1156
315	PLAN CI	3011
315	PLAN BI, IM	752
318	PLAN E1.1	1331
320	FLAN E J	779
322	PLAN D1.4	1173
323	PEAN BI, IM	752
324	PLAN BILIM	752
325	PLAN AT J	582
326	PLAN DZ.IM	1190
327	PLAN D7.1	1190

ENLARGED UNIT SHEET LISTING					
SHEET	PLAN TYPES				
A410	AL, ALD, ATM, ATDM, AZ				
A411	B1, B1,1, B1,2, B1M, B1,1Mt, B1,2M				
A412	BIA, BI.1A, D1.1A				
A413	\$2,82M				
A414	CT .				
A415	C2, C2.1, C2H, C7.1H				
A416	C3, C3,1, C3M, C3.1M				
A417	D1, D1.2, D1.4, D1.5, D1.6				
A419	D141, D1.1M, D1.3M, D1.4M, D1.5M, D1.6H				
A419	D2, D2.1, D2N, D2.1M				
A420	£1, £1.1, £14£, £1.1M				

,	HINDOW NOTES:
	, ALL MISTIONS AND PARTS DOUGS SHALL TENNYL MISTORS. SAL
•	PECHICATIONS FOR WORK INFORMATION.
	. WINDOW THE ARE HOMINAL - CENERAL CONTRACTOR TO VIENT ALL
i	BOUCH OPENINGS WITH MANUFACEUPERS SPECIFICATIONS.
	S. CONSESCENE WAS PROVIDE ALTERNATE WINDOW STANDFASTURER
	STEEL OWNER AND ARCHITECT APPROVAL, ALTERNATE WINDOWS MUST
1	QUAL SPECIFIED WINDOWS IN QUALITY, PERFORMANCE, AND APPEARANCE
	I, TEMPER NEL GENSS AT THE FOLLOWING LOCATIONS
	-WITHEN 24" FPOW LIGDRS
	- WITHEN 12" FROM FINISHED RED DR
	-Pr ALL DOORS
	-ALONE THE EXCLOSURES.

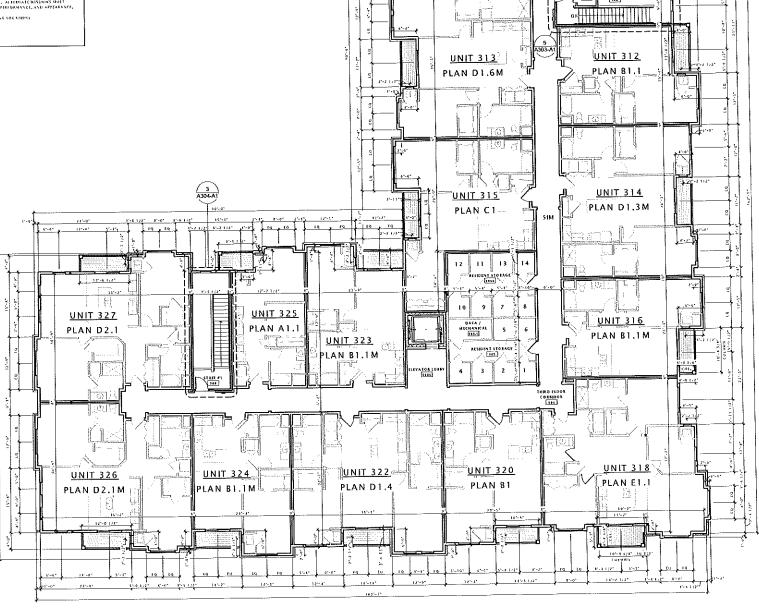

5'-9' 8'-9' 5'-5' 6'E E'E

UNIT 311 PLAN C2.1M

PLAN C2.1





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SPECIFIC IMPLEMENTATION PLAN



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DATE OF ISSUANCE APRIL 21, 2015

REVISION SCHEDULE

Mark Orscription Date

SHEET TIT

BUILDING 'A1' THIRD FLOOR PLAN

CUSET MIMRER

A103-A1

MATE, BURGING TO BY JULY SPINARED PIA 2001 BE, VIPA 17, AD VIPA 18A. 1) ROOF SHALL BE ROOF ASSEMBLY — WI UNLESS NOTED OTHERWISE. TOF CHORDS OF TRUSSES SHALL BE FITCHED AS INDICATED ON ROOF PLAN, SEE ROOF ASSEMBLY SHEET FOR DETAILED (RFORMATION.

2) AT CANOPY ROOF AREAS: PROVIDE TAPERED INSULATION BOARD WHERE NECESSARY OVER ROOF SUBSTRATE TO MAINTAIN A 1/4* PER FOOT MINIMUM FITCH TO ROOF DRAINS/ SCUPPER OPENINGS.

5) ROOF DRAINS, SCUPPERS ARE SHOWN FOR INTENT ONLY. PLUMBING DESIGN, SURD CONTRACTOR SHALL PROVIDE HEESSARY CALCULATIONS AND DETERMINE FIRM, GOARITY, SUR, AND LOCATION OF AGOOD BANKS AND SHALL COORDHATE WITH ROOFING CONT

4) RIDGE VENTS SHOWN ARE FOR DESIGN INTENT ONLY, CONTRACTOR SHALL PROVIDE INTAKE & EXHAUST ROOF VENTS TO FROVIDE 1 5.7, OF VENT AREA PER 300 S.F. OF ATTIC AFEA PER ATTIC COMPARTIENT), OWNERS DISSON FRUID MECHANICAL CONTRACTOR SHALL PROVIDE CALCULATIONS SHOWING FINAL VENTLATION PLAN FRAIOR TO MISTALLATION.

5) OVERHANGS SHALL BE AS SHOWN ON ROOF PLAN.

ROOF

6) PROVIDE ICE & WATER SHIELD AT THE FOLLOWING LOCATIONS (SEE SHADED AREAS ON ROOF PLAN):

ALL FAVES:
RUN FROM EDGE OF FAVE TO 3'-0' (MIN) PAST FACE OF EXTERIOR WALLS.

ALL YALLEYS:
RUN FROM VALLEY TO 3'-0" (WIR.) EACH SIDE OF VALLEY,
INSTALL UNDER METAL FLASHINGS AT VALLEYS.

ALL ROOF/WALL INTERSECTIONS: RUN 3'-0' (UN) HORIZONTALLY FROM FACE OF WALL RUN 1'-6" (UN) VERTICALLY UF FACE OF WALL.

ALL ROOF PENETRATIONS: RUN 3'-0' (MIN.) FROM PENETRATIONS

7) PROVIDE CONTINUOUS ATTIC DRAFTSTOPPING AT LOCATIONS NOTED ON ROOF PLANE, DEALTSTOP SHALL EXTEND FULLY INTO SOFFITS AND ALL PENETRATIONS SHALL BE CAULKED.

8) PROVIDE W' SHAPED METAL FLASHING AT ALL VALLEYS

3) PROVIDE WATER TIGHT INTEGRITY AT ALL PENETRATIONS AND EQUIPMENT PER ROOFING MANUFACTURES STANDARD DETAILS AND GROUNDLEHTS FOR WARRANTY AND CURRENT NEED STANDARDS, SOLICIALULUS CONTRACTORS FROWING GOOF FRIENDLE ATTORNEY FROM THE STANDARD WAS AND THE STANDARD WAS

TO) VENIFY ANY ROOFTOP EQUIPMENT AND PENETRATIONS WITH OWNER DESIGNIEULD MECHANICAL, ELECTRICAL AND PLUMBING PLANS.

JOSEPH LEE ASSOCIATES

JLA PROJECT NUMBER:



FIDUCIARY REAL ESTATE DEVELOPMENT, INC.

SPECIFIC IMPLEMENTATION PLAN



apartments

ELAN RESIDENTIAL DEVELOPMENT

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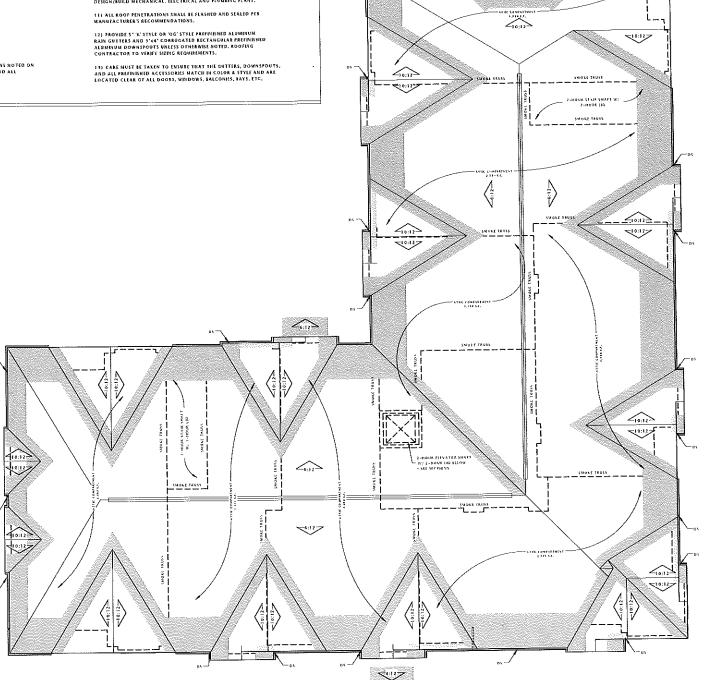
APRIL 21, 2015 DATE OF ISSUANCE REVISION SCHEDULE

Description

SHEET TITLE


BUILDING 'A1' ROOF PLAN

A109-A1







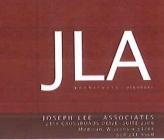

ILA PROJECT NUMBER:



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SPECIFIC IMPLEMENTATION PLAN



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DATE OF ISSUANCE APRIL 21, 2015

REVISION SCHEDULE

Mark Description Date

SHEET TITLE

EXTERIOR ELEVATIONS
'A1' BUILDING

SUCCE NUMBE

A200-A1







JLA PROJECT NUMBER: 14-0515



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REVISION SCHEDULE

Maik Description Date

SHEET TITLE

EXTERIOR ELEVATIONS
'A1' BUILDING

A201-A1



ELAN RESIDENTIAL DEVELOPMENT Fitchrona & Lacy Rd. Fitchburg, Wisconsin





SPECIFIC IMPLEMENTATION PLAN

BUILDING: B1


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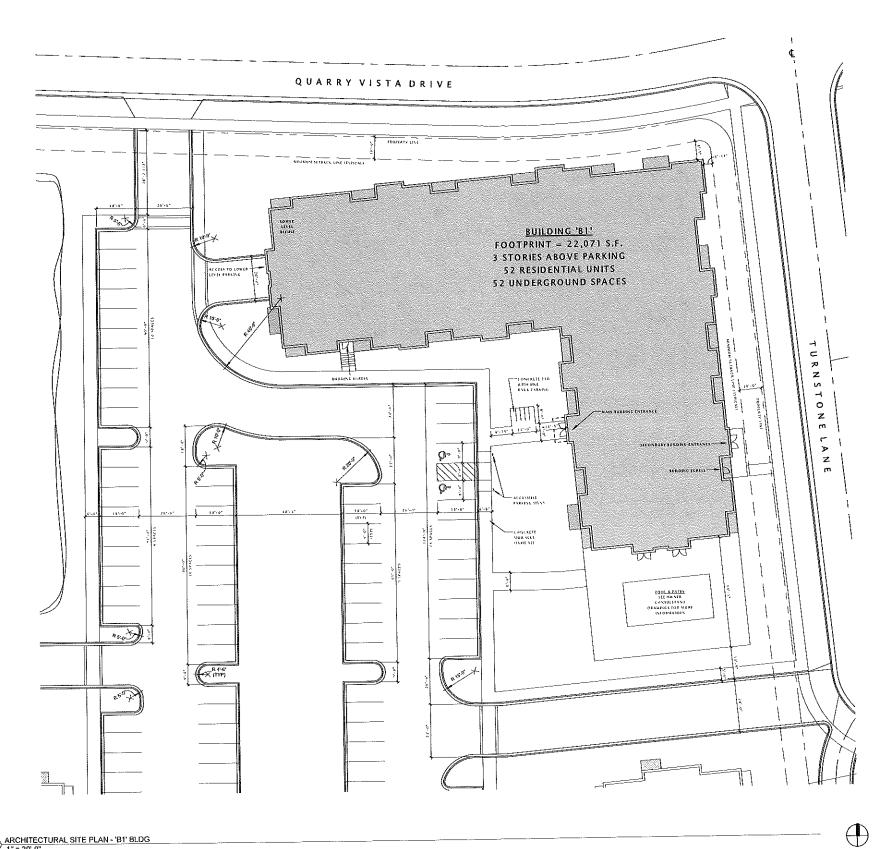
14-0515

APRIL 21, 2015



EXTERIOR BIKE PARKING
1/4" = 1'-0"



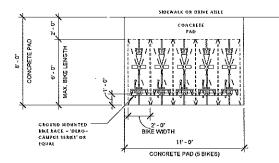



ILA PROJECT NUMBER:



FIDUCIARY REAL ESTATE DEVELOPMENT, INC.

SPECIFIC IMPLEMENTATION PLAN



apartments

ELAN RESIDENTIAL DEVELOPMENT


PROGRESS DOCUMENTS

DATE OF ISSUANCE APRIL 21, 2015

ARCHITECTURAL SITE PLAN - BUILDING 'B1'

ASP101-B1

ARCHITECTURAL SITE PLAN - 'B1' BLDG

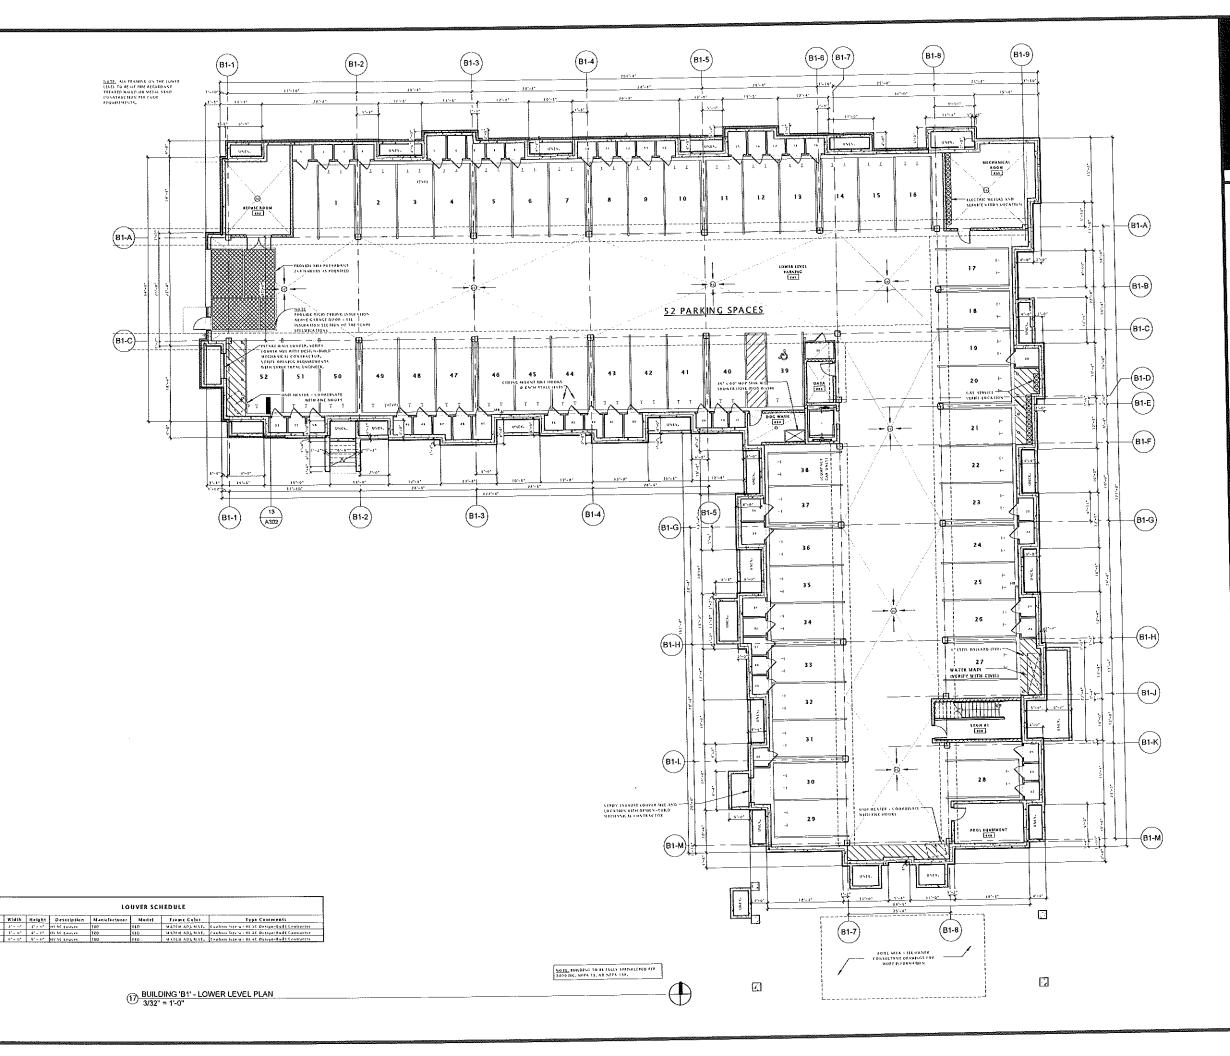



JEA PROJECT NUMBER: 14-051



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SPECIFIC IMPLEMENTATION PLAN



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OF ISSUANCE	APRIL	
REVISION S	CHEDULE	


Mark Description Da

CUCCT TITLE

BUILDING 'B1' LOWER LEVEL PLAN

SHEET NUMBER

A100-B1

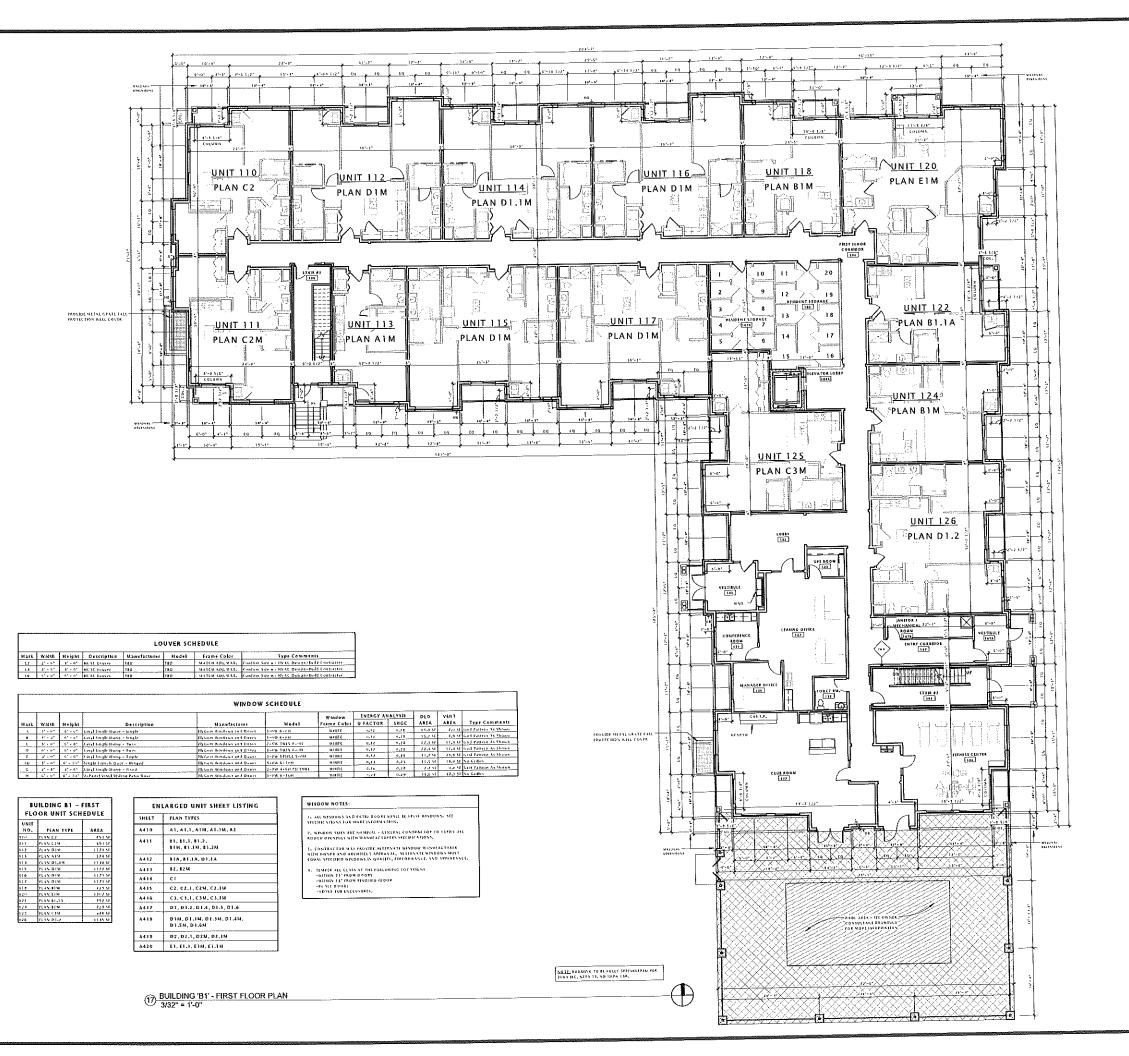



)LA PROJECT NUMBER: 14-0515



FIDUCIARY REAL ESTATE DEVELOPMENT, INC.

SPECIFIC IMPLEMENTATION PLAN



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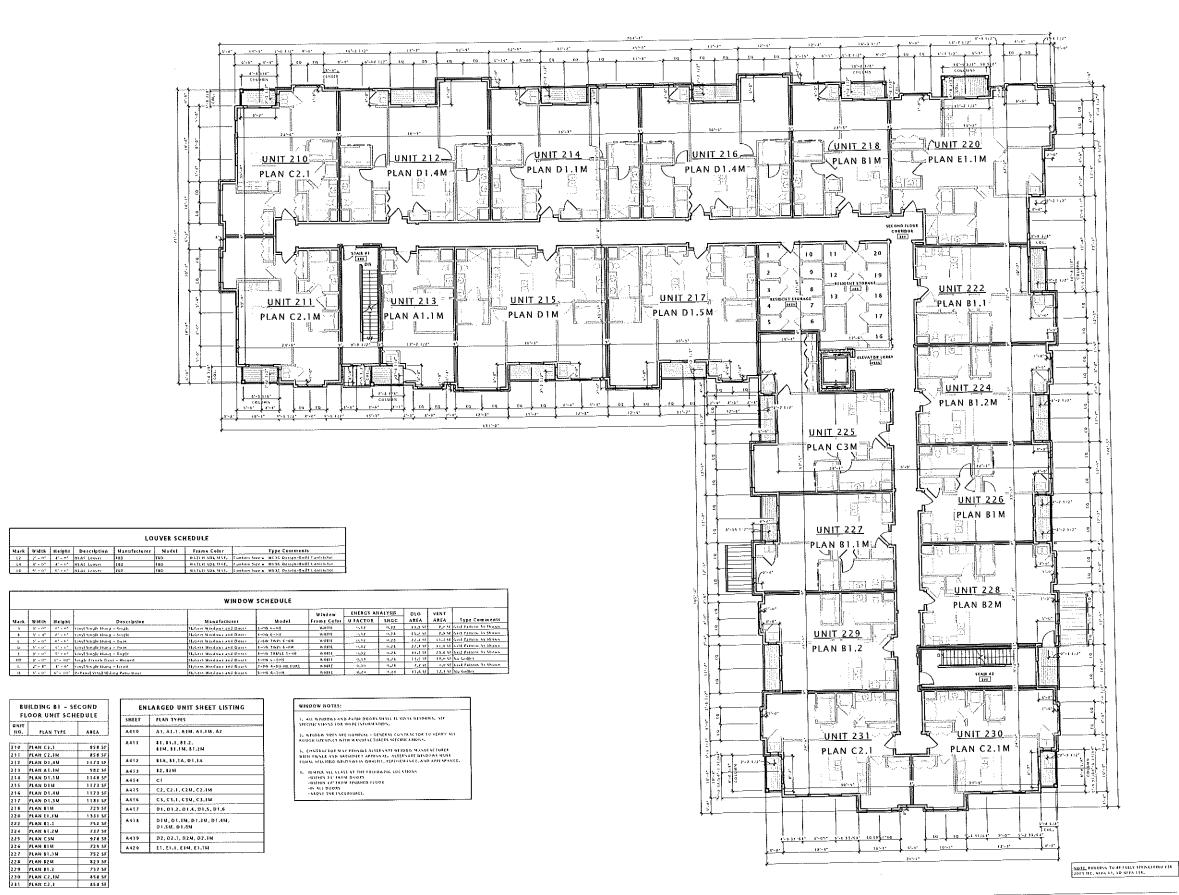
Mark Description Date

SHEET TITLE

BUILDING 'B1' FIRST FLOOR PLAN

SHIFFT NUMBER

A101-B1





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SPECIFIC IMPLEMENTATION PLAN

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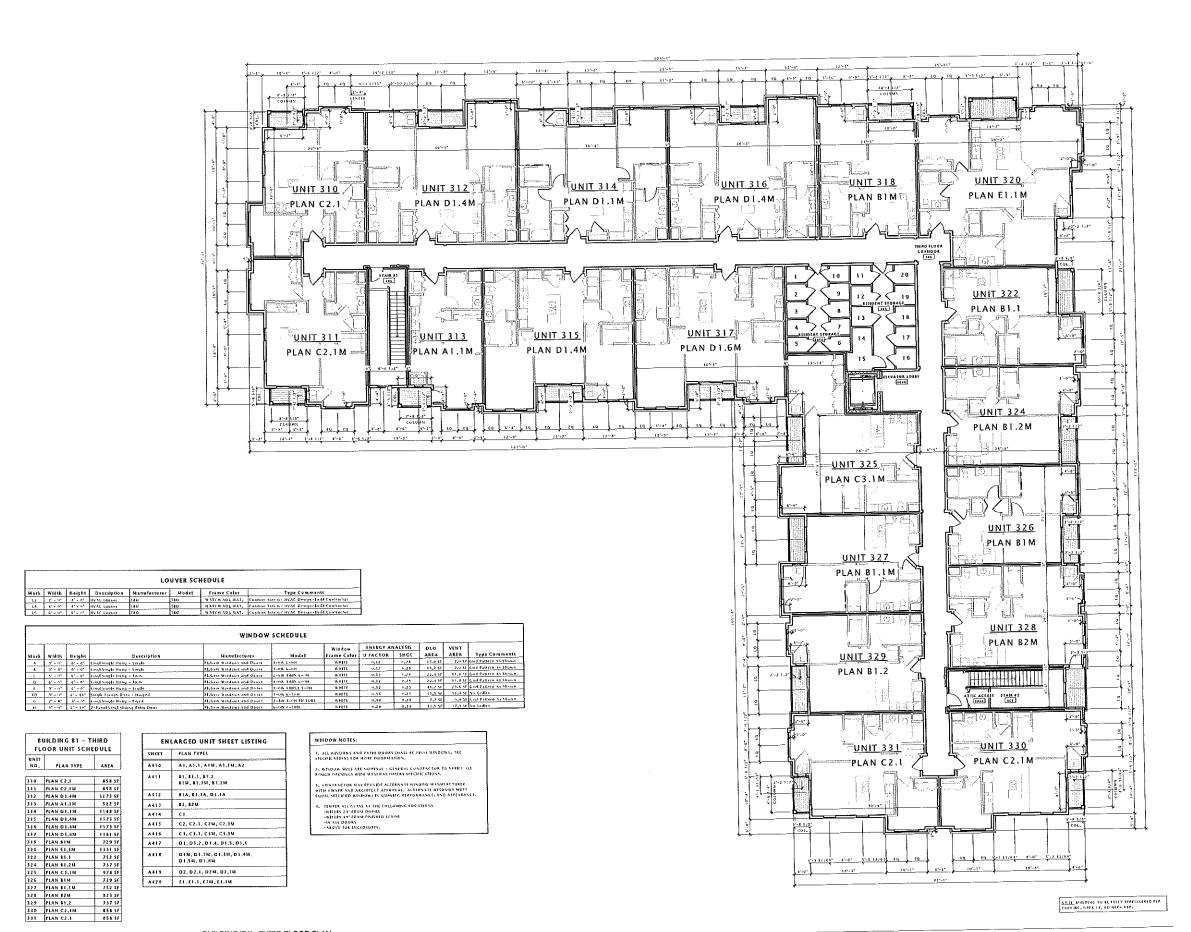
APRIL 21, 2015 DATE OF ISSUANCE

SHEET TITLE

BUILDING 'B1' SECOND FLOOR PLAN

A102-B1

BUILDING 'B1' - SECOND FLOOR PLAN
3/32" = 1'-0"




TOSEPH LEE ASSOCIATES FIDUCIARY REAL ESTATE DEVELOPMENT, INC. SPECIFIC IMPLEMENTATION PLAN ELAN RESIDENTIAL DEVELOPMENT PROGRESS DOCUMENTS These documents reflect progress and latent and may be subject to change, including additional destil. These are not final construction documents and should not used for final bidding or construction-related purposes. APRIL 21, 2015 DATE OF ISSUANCE REVISION SCHEDULE Description

> BUILDING 'B1' THIRD FLOOR PLAN

SHEET NUMBER

A103-B1

BUILDING '81' - THIRD FLOOR PLAN
3/32" = 1'-0"

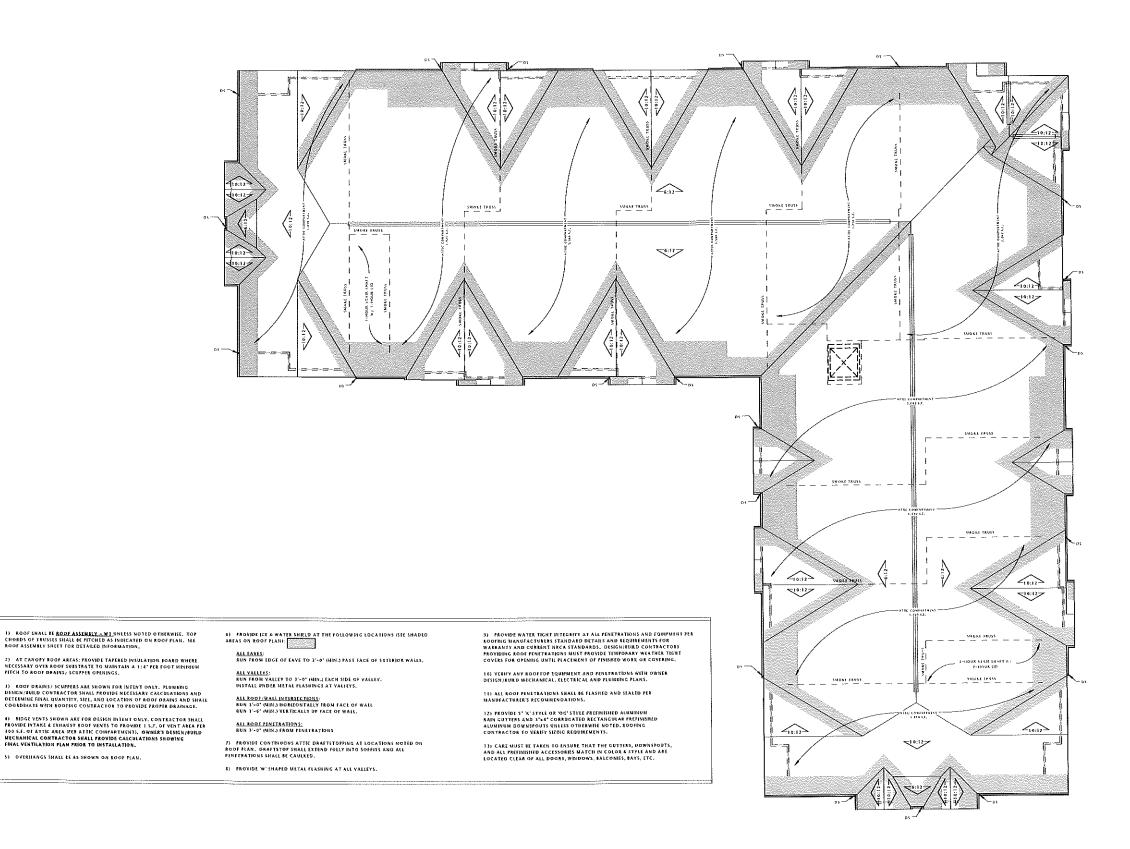

JOSEPH ALE. .. ASSOCIATES JLA PROJECT NUMBER:



FIDUCIARY REAL ESTATE DEVELOPMENT, INC.

SPECIFIC IMPLEMENTATION PLAN



apartments

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DATE OF ISSUANCE APRIL 21, 2015 REVISION SCHEDULE Description

SHEET TITLE

BUILDING 'B1' ROOF PLAN

A109-B1

NOTE BUNDING TO BE THALLY SPANNIERED PER 2009 ISC. LEPA 13. AD NIFA 138.

NOTES

ROOF

DVERHANGS SHALL BE AS SHOWN ON LOOF PLAN.





16 NORTH ELEVATION - B1



LA PROJECT NUMBER:



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SPECIFIC IMPLEMENTATION PLAN



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DATE OF ISSUANCE APRIL 21, 2015

REVISION SCHEDULE

Mark Description Date

SHEET TITLE

EXTERIOR ELEVATIONS
'B1' BUILDING

SHEET NUMBE

A 2 0 0 - B 1



JOSEPH LEE ASSOCIATES
24 % CIUS SBOADS BRIVE SUITE 2100
Midrian Wisconia SI/18
252 (231 3500)

PROJECT NUMBER: 14-0



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SPECIFIC IMPLEMENTATION PLAN



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REVISION SCHEDULE					
Mark	Description	on Date			

SHEET TITLE

EXTERIOR ELEVATIONS
'B1' BUILDING

SHEET NUMB

A201-B1

6 EAST ELEVATION - B1 1/8" = 1'-0"



(16) WEST ELEVATION - B



ELAN RESIDENTIAL DEVELOPMENT Fitchrona & Lacy Rd. Fitchburg, Wisconsin





SPECIFIC IMPLEMENTATION PLAN

BUILDING: B2


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JLA PROJECT NUMBER:

14-0515


APRIL 21, 2015



EXTERIOR BIKE PARKING

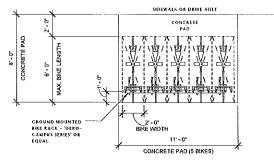

EXTERIOR BIKE RACK STYLE
1/8" = 1"-0"

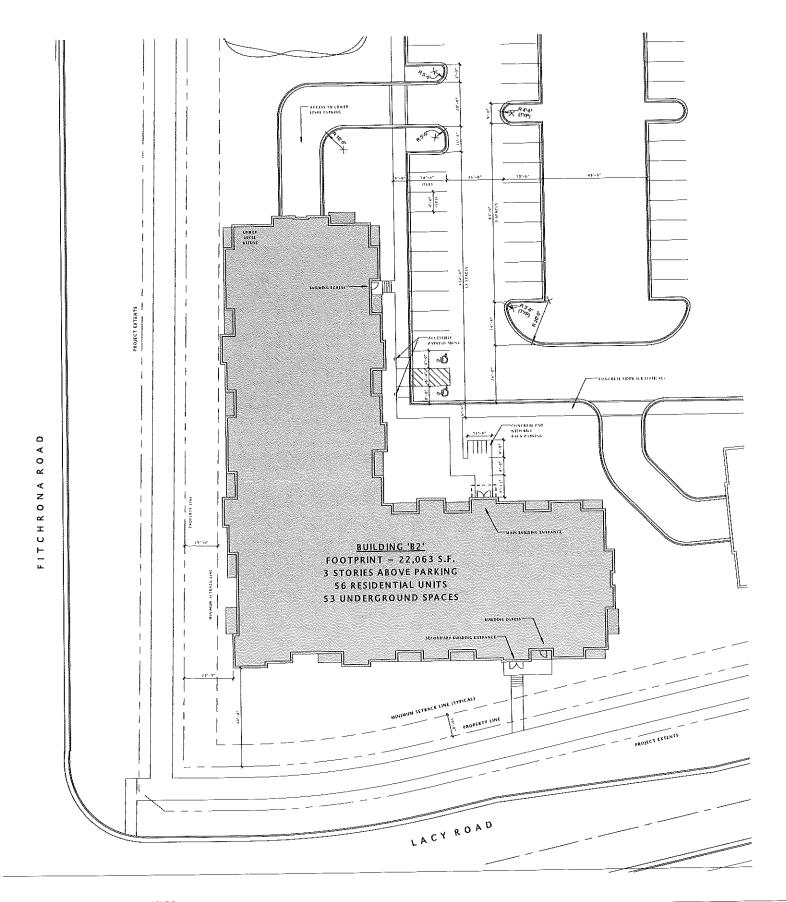



JLA PROJECT NUMBER:



FIDUCIARY REAL ESTATE DEVELOPMENT, INC.

SPECIFIC IMPLEMENTATION PLAN



apartments

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PROGRESS DOCUMENTS


APRIL 21, 2015 DATE OF ISSUANCE

SHEET TITLE

ARCHITECTURAL SITE PLAN - BUILDING 'B2'

ASP101-B2

1" = 20'-0"

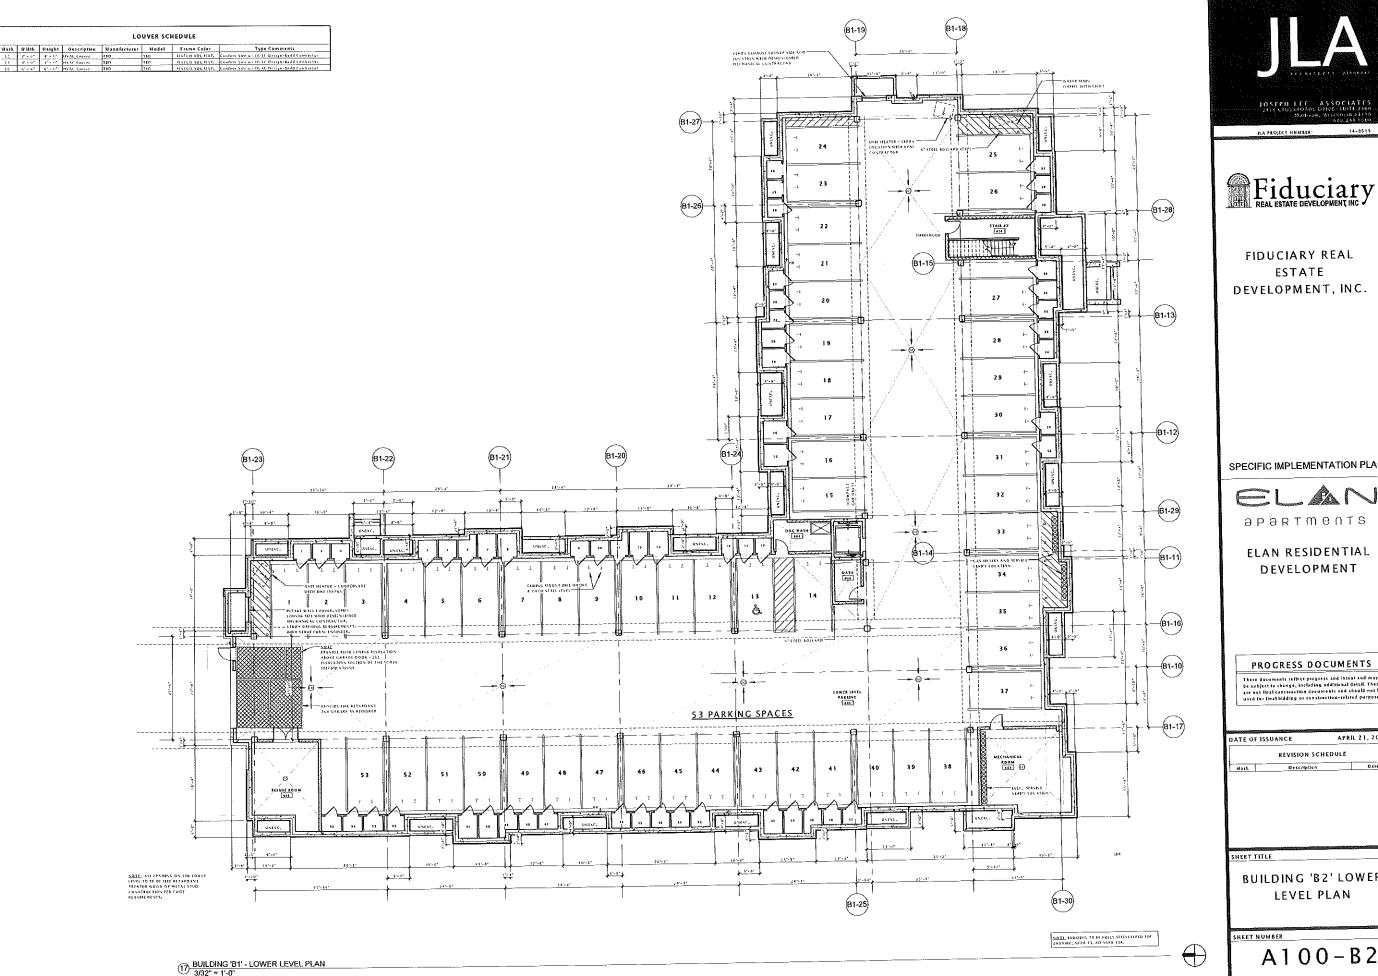





FIDUCIARY REAL ESTATE DEVELOPMENT, INC.

SPECIFIC IMPLEMENTATION PLAN



ELAN RESIDENTIAL

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APRIL 21, 2015 REVISION SCHEDULE

> BUILDING 'B2' LOWER LEVEL PLAN

> > A100-B2



	LOUVER SCHEDULE								
Mark	Width	Height	Description	Manulacturer	Model	Frame Color	Type Comments		
17	2" = 11"	47 - 65	HVAC Louver	TBO	TID	MATEM ADL MAT.	Confirm Strums Ht AC Design-Build Contractor		
()	f t-,	1 4.	INAL Louver	180	110	MATCH AGE WAT.	Confirm free w./ HVAC Design-Suild Contractor		
	42	61.44	backs from a	ten	116	H 14 2 14 1 10 1 H 1 2	Conformation or HEAC Distributed Comparison		

8UILDING B2 - THIRD FLOOR UNIT SCHEDULE						
UNIT	PLAN TYPE	AREA				
LES	MAN CA, I	PS E SE				
111		4565				
112	PLAN CZ.EU					
113	CLAN BY	F23 49				
	MAN 81/24	717 1				
114	FLAN B1					
115	FLAN BILL	72.2.23				
116	21 A74 B 1.2	712 51				
117	21AN (3.1	>74 51				
lt 8	REAN BILLY	252.50				
120	FEAN ELLI	111114				
122	PLAN BI	72911				
171	TEAN DIVE	1173.4				
525	FLAN DILS	11714				
520	PEAN DILIM	115651				
177	21 AN D1,1	11713				
174	MAN DEA	1177 50				
14	FLAN ALL	582 31				
13-2	ELAN C 2,114	858.50				
111	PLAN C 2,1	953.53				

EN	LARGED UNIT SHEET LISTING
SHEET	PLAN TYPES
A410	A1, A1, 1, A1M, A1.1M, A2
A411	51, 83.1, 83.2, 81M, 81.1M, 81.2M
A417	FIA, BLJA, DIJA
A413	\$2, \$2M
A414	c1
A415	C2, C2.1, C2M, C2.1M
A416	C3, C3.1, C3M, C3.1M
A417	D3, D1.2, D1.4, D1.3, D1.6
A418	D1M, D1.1M, D1.1M, D1.4M, D1,5M, D1.6M
A419	D2, D2.1, D2M, D2.1M
A420	EY, ELT, EIM, ELIM

INDOW NOTES: ALL MINDONS AND FATHL BIDDRS SHALL BE MINT WINDONS. SEE FEH'S ATTONS FOR WORLING WATERN.

___ UNIT 127

PLAN D1

CUNIT 126

PLAN D1.1A


12'-9" 12'-3" 11'-2'

UNIT 129

PLAN A1

UNIT 128

PLAN DI

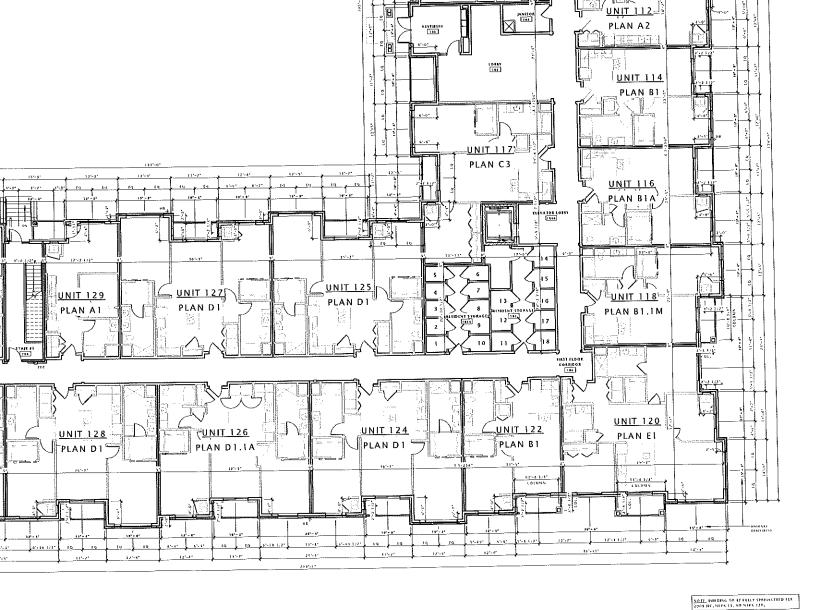

rq 60 57-17 57-07 57-07

-<u>UNIT 110</u>

PLAN C2

STAIR #2

14"- 6"

30'-5"

UNIT 111

=PLAN C2M√

<u>UNIT 113</u>

PLAN BIM

JOSEPH ICE ASSOCIATES

JEA PROJECT NUMBER:

FIDUCIARY REAL ESTATE DEVELOPMENT, INC.

SPECIFIC IMPLEMENTATION PLAN

ELAN RESIDENTIAL DEVELOPMENT

PROGRESS DOCUMENTS

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DATE OF 15 S	UANCE	APRIL 21, 2015				
REVISION SCHEOULE						
Mark	Description	Date				
SHEET TITL	n salah merupak pengganan di dinang manta	Kalliows Illinois Ill Milions il Instrument Milion				

BUILDING 'B2' FIRST FLOOR PLAN

SHEET NUMBER

A101-B2

<u>UNIT 131</u>

PLAN C2

UNIT 130

PLAN C2M




LOUVER SCHEDULE								
Mark	Width	Height	Description	Manufacturet	Hadel	fizme Calar	Type Comments	
L2	?" - 0 "	4" × 10"	HVAC Louves	TED	TEU	MATCH ADD MAT.	Confirm Size to HVAC Design-Suit Contractor	
L1	4" = 9"	4" = 10"	HVAC Lagret	180	TLO	MATCH AGENCAL	Confirm Street HVAC Design - Built Contractor	
1.6	6'-6"	0' - t.*	IIVAC CANARI	180	3 7 0		Confined Size to 1 HVAS Design-Build Contractor	

	ILDING B2 - 1 OOR UNIT SCH	
UNIT NO.	PLAN TYPE	AREA
110	PLAN CZ.I	254
4 E F	FLAN C 2,14	858
112	F1A% 27	9/3
113	FLAN #1.24	212
H	PLAN & I	72,
113	PLAN SEA	252
LIE	FLAN BIJ	217
117	PLAN CILI	971
113	PLAN BILIN	752
120	PLAN ES.I	1331
522	PLUS BY	777
571	FLAN DILL	1173
325	FLAN DIA	1071
126	PLAN DIGH	1150
127	PLAN DI,4	3171
174	PLAN DI.4	1171
129	FLAN 41.3	542
110	ILAS CILIS	156
111	71.AN C 7.3	556

SHEET	PLAN TYPES
A410	A1, A1,1, A1M, A1,1M, A2
A411	83,81.1,83.2, 83M,81.3M.81.2M
A412	BIA, B7.12, D1.1A
A413	62, B2M
A414	C1
A415	C2, C2.1, C2H, C2.1M
A416	C3. C3.1, C3M, C3.1M
A417	D1, D1.2, D1,4, D1.5, D1.6
A418	DIM, DI.IN, DI.3M, DI.4M, DI.5M, DI.6M
A419	D2, D2.1, D7M, D2.1M
A420	EL, EL,1, E1M, E1,1M

, ALL MINDOWS AND PATTS ODORS SHALL BE VINEL WINDOWS, SHE . MINDON SITES ARE RIMINAL - CENERAL CONTRACTOR TO NERHY ALL COUGH DEFINIOS WITH MINDEFACEOFERS SPECIFICATIONS.

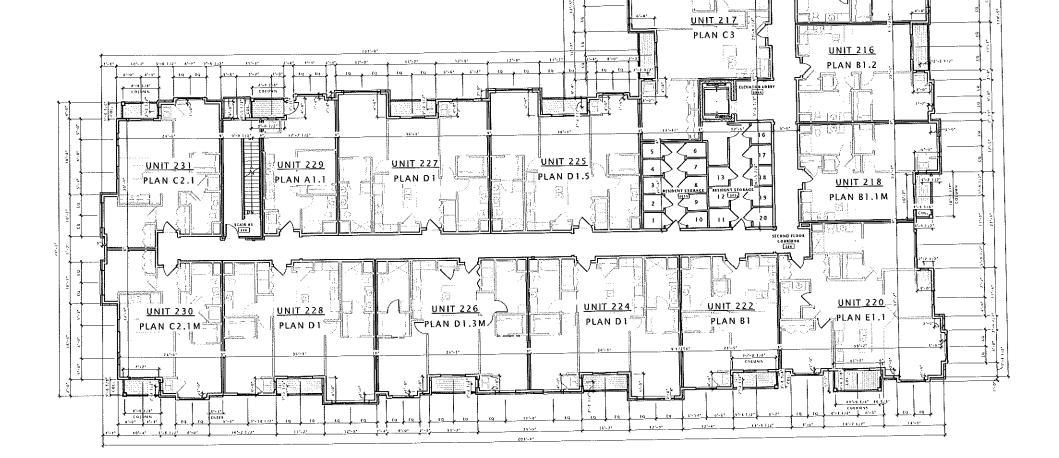

10'-3' 0'-3'

UNIT 210

PLAN C2.1

STAIR #7

UNIT 212 PLAN B2

<u>UNIT 214</u>

PLAN B1

FR'-4"

\$7-07 8'-0" \$7-10 EQ EQ

UNIT 211

PLAN C2.1M

<u>UNIT 213</u>

UNIT 215

PLAN B1.1

6'-0"

PLAN B1.2M

TOSEPH LEE ASSOCIATES

JLA PROJECT NUMBER:

FIDUCIARY REAL ESTATE DEVELOPMENT, INC.

SPECIFIC IMPLEMENTATION PLAN

ELAN RESIDENTIAL DEVELOPMENT

PROGRESS DOCUMENTS

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APRIL 21, 2015 DATE OF ISSUANCE

REVISION SCHEDULE Description

BUILDING 'B2' SECOND FLOOR PLAN

SHEET NUMBER

 \bigoplus

NOTE: RUILDING TO BE FULLY SPRIGHTERED PER 2004 DEC. NEPA 11, AD NERA 118.

A102-B2



\$**0" #**1"

UNIT 331

UNIT 330

PLAN C2.1M

- e 107-4 Y-6 172 8140 16142 1721

PLAN C2.1

	LOUVER SCHEDULE						
Mark	Width	Helght	Description	Manulacturer	Model	Frame Color	Type Comments
1.7	F - D	1 - 0	BYAL Laurer	110	reb	MARCHADL WAL.	Contum Size is 1 MVAC Design-Build Contiertor
6.5	4" - 5"	4'-6"	HWAT LOUVE	110	FED	WATCH ADD MAT.	Continu Size wi HVAC Design-Build Continutur
	6' - 0"		MWAC Laures	100	ran.	MARKE AND MAT	Confirm title by all AC Detremptuals Construction

BUILDING B2 - THIRD FLOOR UNIT SCHEDULE			
UNIT NO.	PEAN TYPE	AREA	
110	PLAN CZ,E	85 a 5F	
51 L	FLAN CZ.LU	858 KF	
112	FLAN 62	823 58	
(1)	FEAS BLOW	737 16	
511	PLAN EI	77951	
111	PLAN & L.F.	752 51	
316	FLAN BILE	23758	
317	PLAN C3,1	2/13	
113	FEAN BILEW	752.5F	
520	FLAS ELJ	113136	
177	PLAY 61	12951	
121	FLAN DLA	1173 50	
525	FLAN DI,6	313350	
176	PLAN DESM	1156 50	
177	PLAN DILA	1173 56	
178	PLAN DILL	1173 51	
129	PLAN AT, I	56230	
13-7	PLAN CALL	454.50	
53 t	PLAN CZ.I	155.16	

EM	LARGED UNIT SHEET LISTING
SHEET	FLAN TYPES
A410	A1, A1,1, A1M, A1,1M, A2
A411	\$1,81.1,81.2, \$1M,01.1M,81.2M
A412	\$1A, \$1.1A, D1.1A
A413	87, 82M
A414	C)
A415	C2, C2.1, C2N, C2.1M
A416	C3. C3.1, C3N, C3.1M
A417	D1, D1,2, D1.4, D1,5, D1,6
A418	D1M, D1.IM, D1.3M, D1.4M, D1.5M, D1.6M
A419	D2. D2.1. D2M, D2.1M
A420	E1, E1.), E1M, E1.1M

INDOW NOTES:

COLUMN

UNIT 329

PLAN A1.1

JUNIT 328

PLAN D1.4


UNIT 327

PLAN D1.4

12-12 12-12 12-12 11-12

UNIT 326

PLAN D1.3M

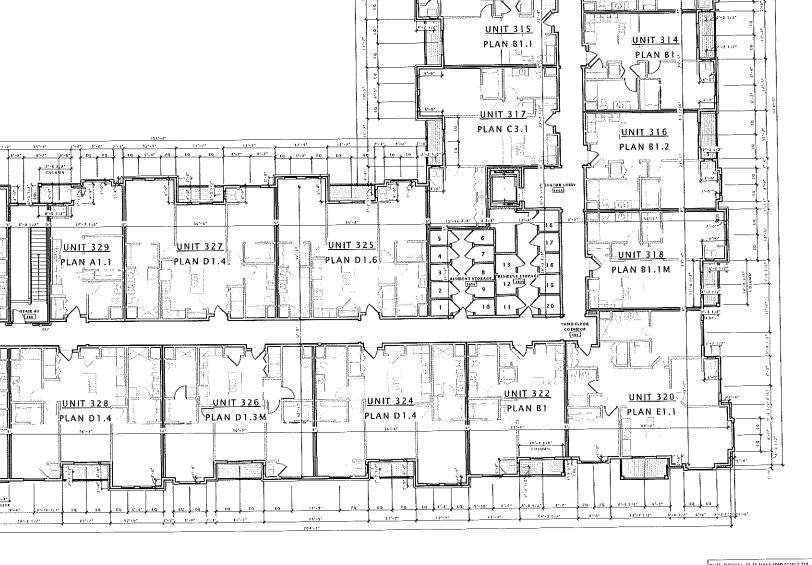

18-1 (-2-) 18-1

51-07 81-07 51-47 60 4 60

<u>UNIT 311</u>

_PLAN C2.1M

<u>UNIT 313</u>

-PLAN B1.2M

Eq. E0 5'-4" C'-9" 5'-6"

<u>UNIT 310</u>

PLAN C2.1.

<u>UNIT 312</u> -PLAN B2: (OL.

JOSEPH LEE ASSOCIATES

JLA PROJECT NUMBER:

FIDUCIARY REAL ESTATE DEVELOPMENT, INC.

SPECIFIC IMPLEMENTATION PLAN

ELAN RESIDENTIAL DEVELOPMENT

PROGRESS DOCUMENTS

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REVISION SCHEDULE	
ark Description Da	Date

BUILDING 'B2' THIRD FLOOR PLAN

SHEET TITLE

A103-B2

BUILDING 'B1' - THIRD FLOOR PLAN
3/32" = 1'-0"

2) AT CANOPY ROOF AREAS: PROVIDE TAPERED INSULATION BOARD WHERE NECESSARY OVER ROOF SUBSTRATE TO MAINTAIN A 1/4" PER FOOT UNINUM FITCH TO ROOF ORAINS/ SCUPPER OPENINGS.

3) ROOF DRAINS) SCUPPERS ARE SHOWN FOR INTENT ONLY. PLUMBING DESIGNAUGH CONTRACTOR SHALL PROVIDE NECESSARY CALCULATIONS AND EXTERNMENT HAVE QUANTITY, SIZE, AND LOCATION OF ROOF DRAINS AND SHALL CORDINATE WITH ADOLFINE CONTRACTOR TO PROVIDE PROFER DRAINAGE.

4) RIDGE VENTS SHOWN ARE FOR DESIGN INTENT ONLY, CONTRACTOR SHALL FROWIDE INTAKE A EXCAUSE ROOF VENTS TO PROVIDE I.S.F. OF VENT AREA PER 2700 S.F. OF ATTIC CAMPATURENTI. OWNERS OBSIGN/BUILD MECHANICAL CONTRACTOR SHALL PROVIDE CALCULATIONS SHOWING FINAL VENTS. AND TO BISTALL ATTION.

S) OVERHANGS SHALL BE AS SHOWN ON ROOF PLAN.

ROOF

ALL FAVES: RUN FROM EDGE OF EAVE TO 1'-0' (MIN.) PAST FACE OF EXTERIOR WALLS.

ALL VALLEYS:
RUN FROM VALLEY TO 3'-9' (MIN.) EACH SIDE OF VALLEY,
INSTALL UNDER METAL FLASHINGS AT VALLEYS,

ALL ROOF WALL INTERSECTIONS:
RUR 3'-0" (MIR.) HOMEONTALLY FROM FACE OF WALL
RUN 1'-6" (MIN.) VERTICALLY DP FACE OF WALL.

ALL ROOF PENETRATIONS: RUN 3'-0" (MIR.) FROM PENETRATIONS

7) PROVIDE CONTINUOUS ATTIC DRAFTSTOPPING AT LOCATIONS NOTED ON ROOF PLAN. DRAFTSTOP SHALL EXTEND FULLY INTO SOFFITS AND ALL PENETRATIONS SHALL LE CAULKÉD.

9) PROVIDE WATER TIGHT INTEGRITY AT ALL PENETRATIONS AND EQUIPMENT PER ROOFING MANUFACTURERS STANDARD DEFAILS AND REQUIREMENTS FOR WARRANTY AND CURRENT NEWS ATANDARDS. DISTING/BURD CONTRACTORS PROVIDING GOOF PEMETAATIONS MUST PROVIDE TEMPORARY WEATHER HIGHT COYERS FOR DEPRINING UNIT, PLACEMENT OF FINISHED WORK NO COVERING.

10) YERIFY ANY ROOFTOF EQUIPMENT AND PENETRATIONS WITH OWNER DESIGN/BUILD MECHANICAL, ELECTRICAL AND FLUMBING PLANS.

IF) ALL ROOF PENETRATIONS SHALL BE FLASHED AND SCALED FER MANUFACTURER'S RECOMMENDATIONS.

12) FROVIDE 5" 'K' STYLE OR 'OG' STYLE PREFINISHED ALUMINUM RAIN GUTTERS ARD 3"54" CORRUGATED RECTRIGULAR PREFINSHED ALUMINUM DOWNSPOUTS UNLESS OTHERWISE NOTED, ROOFING CONTRACTOR TO VERIFY SIZING REQUIREMENTS.

13) CARE MUST BE TAKEN TO ENSURE THAT THE GUTTERS, DOWNSPOUTS, AND ALL PREFINISHED ACCESSORES MATCH IN COLOR & STYLE AND ARE LOCATED CLEAR OF ALL DOORS, WINDOWS, BALCONIES, BAYS, ETC.

JOSEPH LEE ASSOCIATES JEA PROJECT NUMBER:



FIDUCIARY REAL ESTATE DEVELOPMENT, INC.

SPECIFIC IMPLEMENTATION PLAN



apartments

ELAN RESIDENTIAL DEVELOPMENT

PROGRESS DOCUMENTS


These documents reflect progress and Intent and may be subject to change, including additional detail. These are not linal construction documents and should not used for final bidding or construction-related purposes.

	REVISION SCHEDULE				
Mark	Description	Date			

BUILDING 'B2' ROOF PLAN

NOTE: FURDING TO BE FULLY SPRINKLERED PER 7009 INC., NIPA 13. AD NEPA 138.

A109-B2

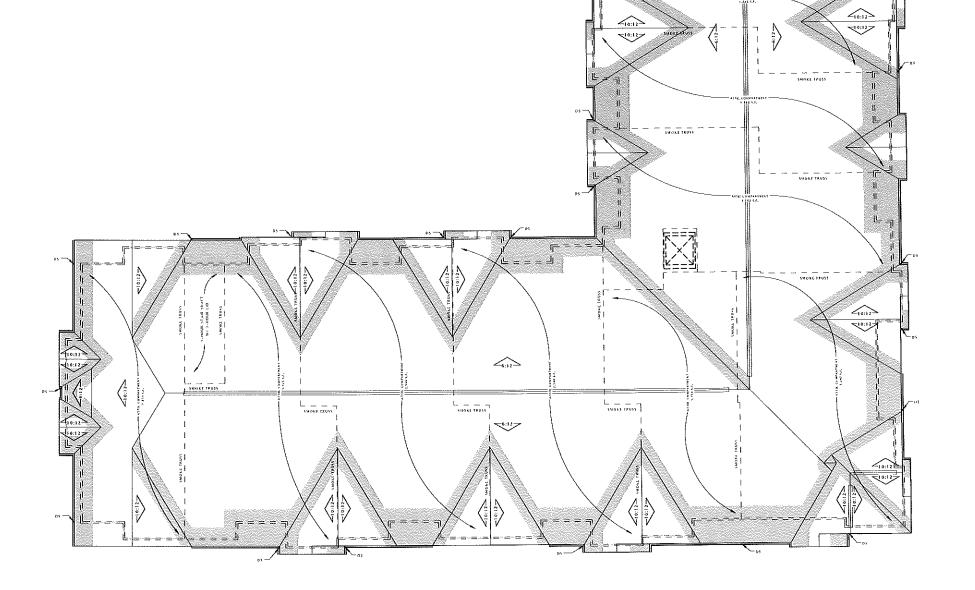


10:12





16 NORTH ELEVATION - B2

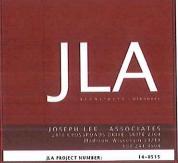



FIDUCIARY REAL
ESTATE
DEVELOPMENT, INC.

SPECIFIC IMPLEMENTATION PLAN



ELAN RESIDENTIAL DEVELOPMENT

PROGRESS DOCUMENTS

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DATE OF ISSUANCE APRIL 21, 2015

REVISION SCHEDULE

Mark Description Date

SHEET TITLE

EXTERIOR ELEVATIONS
'B2' BUILDING

SHEET NUMBE

A200-B2



6 EAST ELEVATION - B2 1/8" = 1'-0"

(16) WEST ELEVATION - B2

JOSEPH LEE ASSOCIATES
2112 CROSSROAD CRIVE SUITE 2/19
HICKORY, WISCONS IN 21/18
SCR 2/21 5/20
JIA PROJECT NUMBER: 14-8515

Fiduciary REAL ESTATE DEVELOPMENT, INC.

FIDUCIARY REAL
ESTATE
DEVELOPMENT, INC.

SPECIFIC IMPLEMENTATION PLAN



ELAN RESIDENTIAL DEVELOPMENT

PROGRESS DOCUMENTS

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DATE OF ISSUANCE APRIL 21, 2015

REVISION SCHEDULE

Mark Description Date

HEET TITLE


EXTERIOR ELEVATIONS
'B2' BUILDING

A201-B2



APPENDIX 'D' SIGN PROGRAM



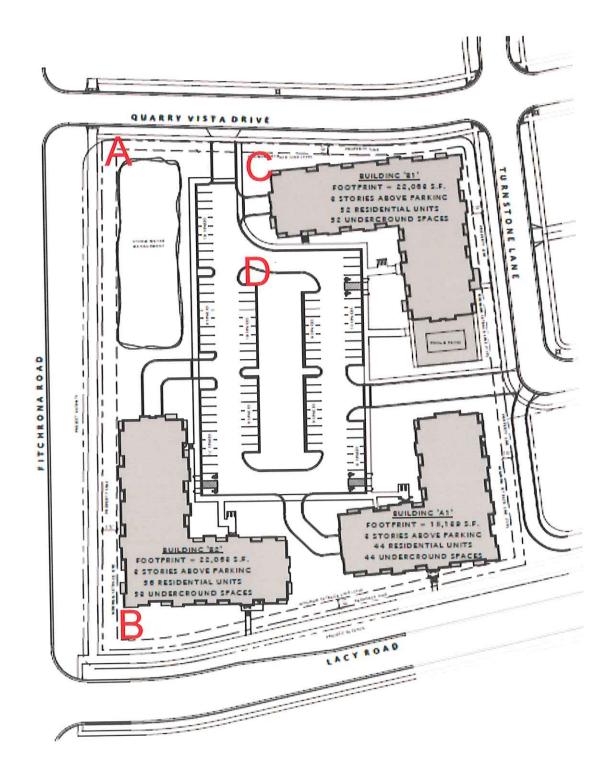

ELAN APARTMENTS = FITCHBURG, WI Location : A & B 8'-0" 7" 608.111.1111 4" a" a Partments.com 13/4"

Scale 1"=1'-0"
(2) 4'h x 8'w x 1/2"MDO Plywood Now Leasing Signs Rev1
Digital printed on vinyl applied to boards
Installed on 4x4 posts.



Customer ELAN APARTMENTS


Street City FITCHBURG, WI Date:
4.17.15
Acct. Rep.
James Miller

Designer: JEM
Drawing No. Leasing sign41715
Revision 1
Scale:

Client Approval
Signature:
Print:
Date:

Landlord Approval Signature: Print: Date: Wisconste fign & Organica, Lucis the sele owner of the unswead (Drawings, other renderings arrived sign concepts) used to submit to disnift for approvable Reproduction to whole or part with out written permission. Wisconsin Sign & Graphics, LLC Copyright Wisconste Sign & Graphics, LLC Copyright Wisconste Sign & Graphics, LL 2014

Elan Apartments

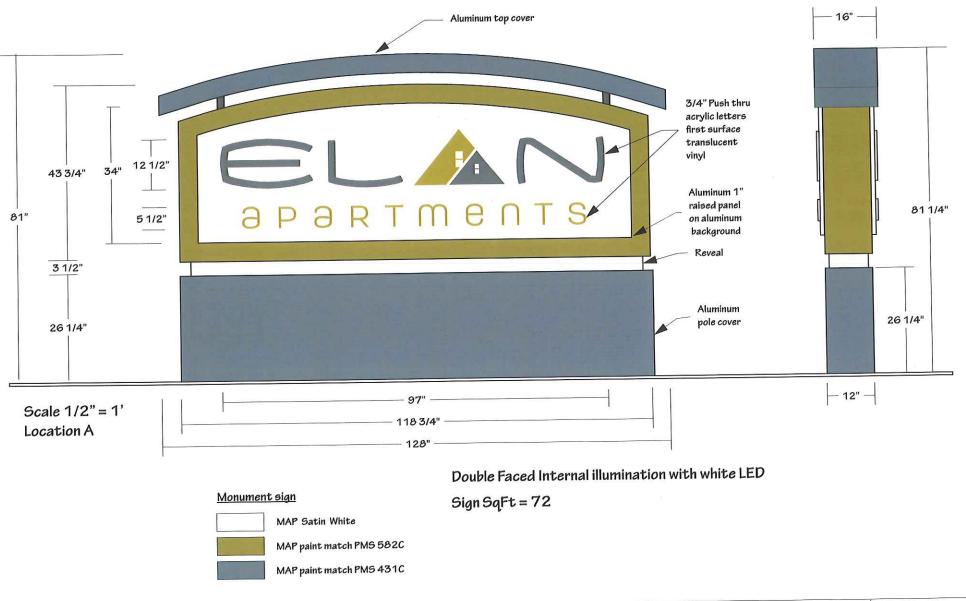

Customer Fiduciary_ Elan Street City Fitchburg, WI


Acct. Rep. James Miller Designer: M Studnicka Drawing No. Elan Sign A Revision Scale: Client Approval Signature: Print: Date: Landlord Approval Signature: Print: Date: Wisconsin Bign & Graphica, Lic is the sole owner or this artwork (Drawings, color renderings around or sign concepts) used to submit to client for approximation whele or part with out written permission of the color of the col

Signs For Your

Date: 4.20.15

ELAN APARTMENTS - FITCHBURG, WI

Location: C and D

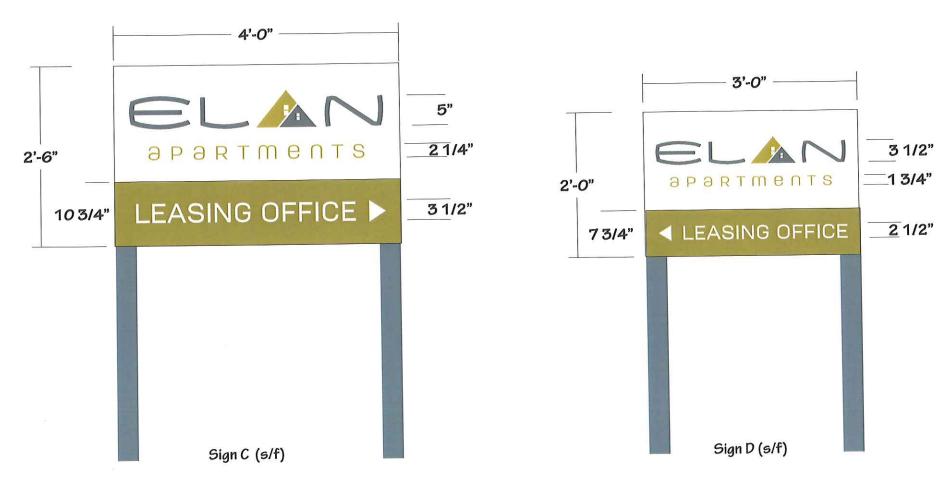

TEMPORARY SIGNS C & D

(2) 1/2"MDO Plywood Now Leasing Signs Rev1 Digital printed on vinyl applied to boards Installed on 4x4 posts.




Customer ELAN APARTMENTS
Street
City FITCHBURG,WI

Date: 4.17.15 Acct. Rep. James Miller Designer: JEM
Drawing No. Leasing sign41715
Revision 1

Client Approval Signature: Print: Landlord Approval Signature: Print: Date: Wisconsin Sign & Supplies, tacis his sold connect of the attention (Drawings, other redelings armider sign concepts) used to submit to defin for approval. Reproduction in whole or part who set written permitsion! Wisconsin Sign & Graphites, LLC approval of the set of the set

Elan Apartments

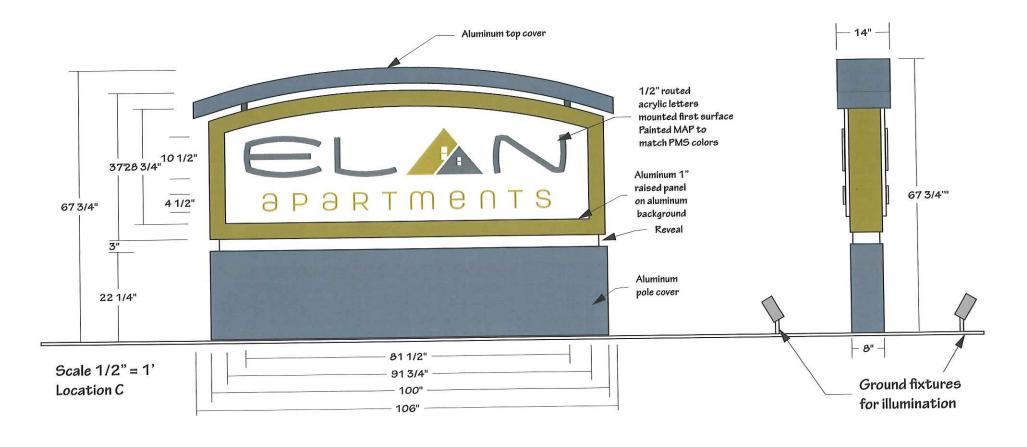



Double Faced non-illuminated Sign SqFt = 49.872



Customer Fiduciary_ Elan Street City Fitchburg, WI


Date: 4.20.15

Acct. Rep. James Miller

Designer: M Studnicka Drawing No. Elan Sign C Revision Scale:

Client Approval Signature: Print: Date:

Landlord Approval Signature: Print: Date:

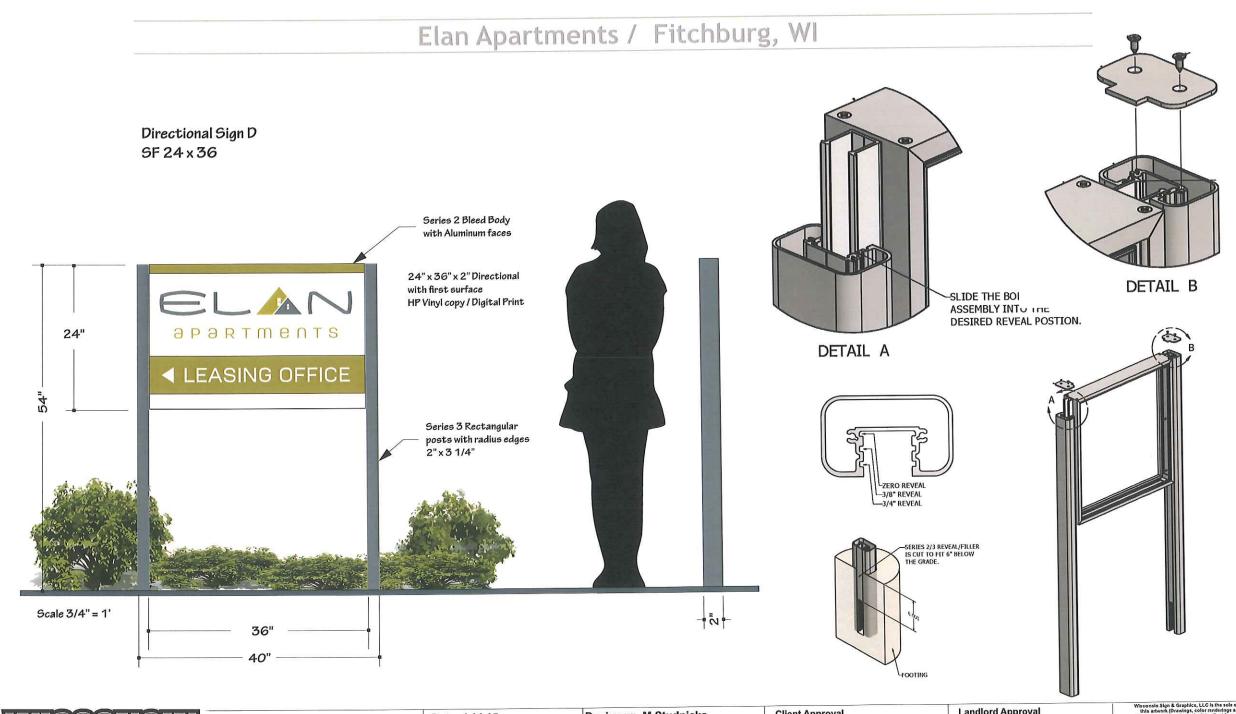

Acct. Rep. James Miller

APPENDIX 'E' NEIGHBORHOOD INPUT INFORMATION

Invite list for 10-14-14 Neighborhood meeting
Fiduciary Real Estate Development - Quarry Vista Multi-Family

BEYLER LIVING TR	6342 PHEASANT LN	VERONA WI 53593
BRAD D ANDERSON	2712 FITCHRONA RD	FITCHBURG WI 53719
COREY L DINTELMAN	2706 FITCHRONA RD	FITCHBURG WI 53711
DANE COUNTY	210 MARTIN LUTHER KING JR BLVD RM 114	MADISON WI 53703-3342
DIANE REMEIKA	1321 MORRISON ST	MADISON WI 53703
EARLE N WILLIAMS & ARISA M WILLIAMS	2687 FITCHRONA RD	MADISON WI 53719
FITCHBURG MINERALS LLC	6295 LACY RD	VERONA WI 53595
FITCHBURG, CITY OF	5520 LACY RD	FITCHBURG WI 53711
GREGORY A LUKAS & DIANE M LUKAS	7330 SOUTHERN OAK PL	MADISON WI 53719
HAMM FAM LAND LLC	6244 OAK HOLLOW DR	OREGON WI 53575
HAMMERSLEY, KEITH E	6291 LACY RD	FITCHBURG WI 53593
JOHN H ELLINGER	2720 FITCHRONA RD	FITCHBURG WI 53719
JOHNSON REV LIVING TR, MARTIN H	6355 PHEASANT LN	VERONA WI 53593
KENNETH E KAEGI & TERESA J KAEGI	6344 GOOSE LAKE DR	VERONA WI 53593
KENNETH O KOBERLE & JUDITH KOBERLE	2669 FITCHRONA RD	MADISON WI 53719
KEVIN N WUNDER & LORIANN S WUNDER	6353 GOOSE LAKE DR	VERONA WI 53593
LARRY J STARCZYNSKI & SHERRY L STARCZYNSKI	2701 FITCHRONA RD	MADISON WI 53719
MADISON METROPOLITAN SEWERAGE DISTRICT	1610 MOORLAND RD	MADISON WI 53713
MAURER TR	2657 FITCHRONA RD	VERONA WI 53593
NATHAN HAMMERSLEY	6310 LACY RD	FITCHBURG WI 53593
NSNK LLC	6291 LACY RD	VERONA WI 53593
PAYNE & DOLAN INC	PO BOX 781	WAUKESHA WI 53187
PRINGLE LIVING TR	2700 FITCHRONA RD	FITCHBURG WI 53719
ROBERT D KOHLENBERG & NORMA K KOHLENBERG	2653 FITCHRONA RD	VERONA WI 53593
SCOTT C LITTLE & SHEILA A LITTLE	6350 PHEASANT LN	VERONA WI 53593
TODD E MEURER & HOLLY M DOWLING	6352 GOOSE LAKE DR	VERONA WI 53593
VIVIAN G KILLERLAIN	6341 PHEASANT LN	VERONA WI 53593
Amanda Arnold, Town of Verona	335 N. Nine Mound Road	Verona, WI 53593-1035



October 3, 2014

Proposed 152-unit Apartment Home Project Hamm Fam Land, LLC lands Outlot 9 of the plat of Quarry Vista NW ¼ of the NW ¼ of Section 18

Dear Neighbor,

This letter is in regards to our proposed Apartment Home development located in the City of Fitchburg, near your property at the intersection of Lacy and Fitchrona Roads. Please find the following:

Location map depicting our property and the surrounding neighborhood

 11"x17" color rendered Concept Plan of our project which was reviewed by the City Plan Commission at their meeting on September 16, 2014.

We will be submitting our full General Implementation Plan (GIP) for the project by the City's Tuesday October 21, 2014 deadline in order to be on the City Plan Commission meeting agenda on Tuesday, November 18, 2014.

In order to solicit your input on the proposed design, we would like to invite you to an Open House:

Tuesday, October 14, 2014 from 5:30 to 6:30 PM

The open house will be held at the Hammersley Stone Offices, 6291 Lacy Road, Fitchburg, WI 53593

Again, we would appreciate any input you have on our plans and please do not hesitate to contact me (information below) if you have any questions or need additional information.

Sincerely,


Fiduciary Real Estate Development, Inc.

William F. Ohm Project Manager

Direct line 414-274-8212 Email bohm@fred-inc.com

789 North Water Street • Milwaukee, Wisconsin 53202 • (414) 226-4535 • Facsimile: (414) 226-4549 • www.fred-inc.com

Sample Attachment to Neighborhood Meeting Invitation

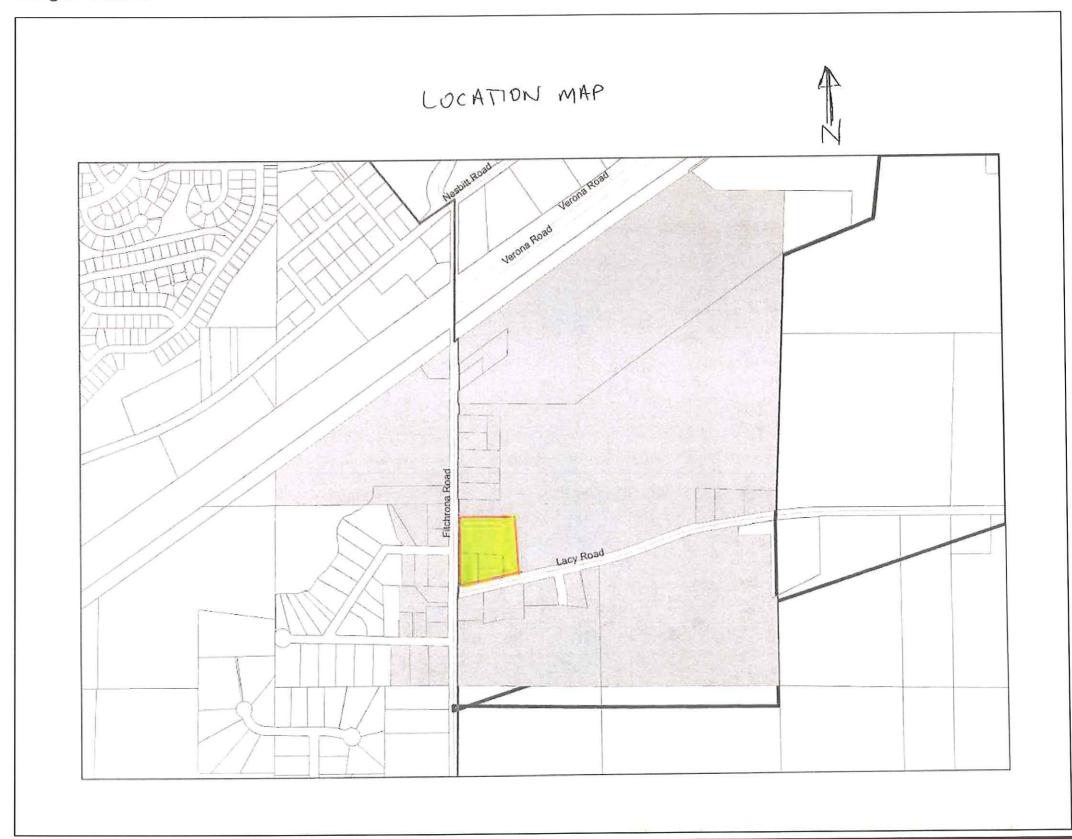

Sample Attachment to Neighborhood Meeting Invitation



Neighborhood Meeting Sign-In Sheet

HAMMERSLEY STØNE CO. NC.	8		A C STREET, STEERING
Grading and Utility Construction Crushed Stone Supplies	A Particular Control		6291 Lacy Rd Fitchburg, WI 53593 Phone: (608) 845-7804 Fax: (608) 845-5532
Detaber 14, 2014 Meeting which Neig Fuctions Localistate	hborhee	nc/	
Geral Krouse Gary Aebly		Tonto Tra: 1	1
Essent Koncossers Ellen France Gen Espect		FITCHALVA R Fillinga Rd Fitchrena Rd	4
Diane of the Median Todd Median		Gouse Lake 1	
(Payno and Delan)		6295 Lecy 1	Zel





CITY OF FITCHBURG PLANNING DEPARTMENT

5520 LACY ROAD FITCHBURG, WI 53711 (608) 270-4200 FAX: (608) 270-4275

EMAIL: planning@city.fitchburg.wi.us

Application: RZ-2057-15 & ADR

Property Location: Proposed Lot 15 Quarry Vista

Review Date: April 27, 2015

Planning Staff Review #1

Planning staff has reviewed your submitted PDD-SIP zoning and ADR requests for proposed Lot 15 Quarry Vista, submitted on 4/21/2015. The following comments are based on this review. Please respond to these comments with a detailed written response along with appropriate revised plans by Noon on Wednesday, May 6, 2015. Further comments or questions may arise as additional review occurs.

- 1.) Has there been any neighborhood contact/input since October 2014? No. Have the neighbors seen the building elevations? Yes, at the meeting in October 2014 when we had the first unveiling of the colored renderings of the building elevations. You should be aware that there is a public hearing as part of the PDD-SIP rezoning approval process and property owners within 300 feet of the subject property will be directly notified of the request. This is understood.
- 2.) Per Ordinance 2014-O-37, approving PDD-GIP zoning for the site, approval and recording of a land division (i.e. final plat) is required prior to SIP issuance. You should be aware that a subdivision improvement agreement is required to be executed prior to the final plat being signed by the city and subsequently recorded. It is my understanding that the developer has been working on this agreement with Public Works.
- 3.) Subdivision Improvement Agreement is required prior to SIP issuance.
- 4.) Necessary public improvements shall be installed and accepted prior to any building construction, unless approvals are granted to allow early start under section 24-14(b)-(e). (An operable public water supply is one necessary condition under section 24.14 of the City's land division ordinance).
- 5.) Is all exterior lighting dark sky or full cut-off? Full cut-off.
- 6.) What is the timing of each building? Please see page 15 of the Implementation Plan.
- 7.) The plat approval requires that 80 dwelling units on lots within the first final plat of Quarry Vista shall be occupied within six months of the first unit being occupied. When do you anticipate meeting the 80 units occupied? Fiduciary's absorption at The Vue apartments in Fitchburg has average 30 units per month. We do not expect this to continue, however we feel very confident that 15 units will be absorbed per month (so we will reach 80 in month 6). We anticipate the first delivery of building B1 on May 2016 to be followed by B2 in July 2016.
- 8.) Is there lighting at the pool? What is the type of lighting? Exterior lighting for the pool is not anticipated based on the planned hours of usage.
- 9.) What is the type of composite siding? Painted LP SmartSide Horizontal and Stucco Panel.
- 10.) What is the type of split face block? Block veneer, specified as County Materials Splitface in "Buff".

- 11.)Please bring a materials color and sample board to the Plan Commission meeting. We plan to bring a material sample board as well as a board with 3D imagery.
- 12.) What is the composition of the infiltration mix? 70%-85% sand and 15%-30% compost, per the DNR standards.
- 13.) What is the anticipated total population at build-out? 225 people.

Emailed Craig Raddatz 5/12/15

Elan Apartments - Lot 15 of Quarry Vista Plat 6305? Quarry Vista Drive Public Works Review #4

The following comments are based on the Architectural Design Review (ADR 2015) and rezoning request submitted by Craig Raddatz dated April 20, 2015, amended plans dated May 6, 2015 and Applicant Responses dated for Lot 15 in the Quarry Vista Plat. EJE 5-11-15; TF 5-11-15; AB 5-11-15; CH 5-12-15. Additional comments beyond these may be required on future reviews.

General Comments

1. Please confirm the sizing and location of the refuse and recycling containers. Applicant Response: There is an interior Refuse Room located on the lower level of each building adjacent to the overhead door. The exact type and size of the containers hasn't been determined, but they will be appropriately sized for each multi-family building.

Additional PW Review #4 Comment: Please confirm that both refuse and recycling containers are sized and located properly, not just refuse.

 The applicant will need to submit a Construction & Demolition Reuse/Recycling (CDRR) Plan to Public Works. CDRR Plans are required both for new construction and for demolition.
 Applicant Response: A plan will be prepared and submitted for review.

Transportation Comments

- 1. The driveway configuration out to Stone Gate Drive/Turnstone Lane still has an impact on the Private Drive access. Please share this concept with Montgomery & Associates and coordinate the driveway design at that location. The curb from the site overlaps the public sidewalk. This access point needs further coordination.
 - Applicant Response: This item will be reviewed and additional information provided.
- Consider bike/ped connections from the site to the paths on Lacy Road and Fitchrona Road. A nice connection could be made to the Lacy Road path between buildings A-1 and B-2. Similarly, a connection could be incorporated to the Fitchrona Road path north of Building B-2.
 Applicant Response: This item will be reviewed and additional information
 - Applicant Response: This item will be reviewed and additional information provided.
- Additional PW Review #4 Comment: The plan sheets show curb and gutter along Lacy Road and Fitchrona Road. At this time, both roads will remain with a rural cross-section. The roads may be improved with curb and gutter in the future but not with the Quarry Vista development.

Water Main and Sanitary Sewer

- Coordinate final water and sewer lateral locations with the final approved plans for public works construction in Quarry Vista. Final service locations and sizes need to be shown on the plans. The attached plan shows the location of existing sewer laterals to be used to service two of the three proposed buildings.
 - Applicant Response: See the submitted plan dated May 5, 2015.

Elan Apartments - Lot 15 of Quarry Vista Plat 6305? Quarry Vista Drive Public Works Review #4

2. All water services between the public main up to a private fire hydrant are required to be a minimum of 8" and be installed per the Latest Edition of the City of Fitchburg Standard Specifications for Public Works Construction. Please label and note accordingly.

Applicant Response: See the submitted plan dated May 5, 2015.

- The following notes need to be included on the site utility plan: Applicant Response: See the submitted plan dated May 5, 2015.
 - Safe sample results need to be provided to the Fitchburg Utility prior to pressure testing the private water mains.
 - It is the contractor's responsibility to verify that the existing valves will hold the pressure test prior to connection. The City is not responsible for any costs incurred due to the contractor not verifying that the existing valve will hold the pressure test prior to connection. If a new valve is required, the applicant will be required to install one at their expense at the point of connection.
- 4. Public water for the development and the sewer service off Turnstone Lane will not be available for use until public improvements are accepted for the Quarry Vista plat. Building permits may not be issued until public water is available.

Applicant Response: This is understood.

- 5. Existing sanitary laterals, that will not be reused, will need to be abandoned at the sewer main per the latest edition of the City of Fitchburg Standard Specifications for Public Works Construction. Public Works will need to witness these abandonments. The attached plan shows the location of the existing laterals to be abandoned. Please show and label accordingly. Applicant Response: The noted plan was not attached to the email we received from Susan, please forward us this plan and we will address the lateral abandonments.
 - Additional PW Review #4 Comment. The sanitary lateral to be abandoned on Fitchrona Road at the north end of Lot 15 and the 6" sanitary lateral to be abandoned on Lacy Road need to be abandoned at the manhole, not the main. Please correct.
- 6. All private wells on this site need to be abandoned per DNR requirements. A DNR well abandonment form needs to be submitted to Public Works for each abandoned well.
 - Applicant Response: Well abandonment forms will be provided as required.
- 7. Water impact fees will need to be paid prior to release of any building permits. These fees will be included with the permit fee. The 2015 impact fee rate is \$729/Unit.
 - Applicant Response: This is understood.
- 8. MMSD fees need to be paid for this lot prior to the release of an early start permit.
 - Applicant Response: This is understood.

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9. The Quarry Vista plat conditions require 80 units to be occupied within six months of occupancy of the first unit/single family home within the Quarry Vista plat.

Applicant Response: This is understood.

10. Early start permits may not be issued for this site until award of the Fitchrona Road Water Main Bid is approved by Fitchburg Council.

Erosion Control and Stormwater Management (ECSWM) Comments

- A new Erosion Control & Storm Water Management permit application will need to be submitted to the Fitchburg Public Works Department for review and approval (The ECSWM application and information on requirements can be found at: http://www.fitchburgwi.gov/231/ECSWM-Requirements.
 Applicant Response: The permit application will be submitted the week of May 11, 2015.
- 2. A stormwater maintenance agreement (recorded at the Dane County Register of Deeds office) will be required for the necessary private stormwater management practices approved by the City (e.g. private storm sewer, rain gardens, etc.). The owner(s) would be eligible for up to a 50% reduction in stormwater utility rates for the proposed stormwater practices. The following link: http://www.fitchburgwi.gov/230/Credit-Opportunities provides the application form and details on this program.

Applicant Response: A stormwater maintenance agreement will be submitted following the City's approval of the stormwater management plan.

- 3. This site is within the Quarry Vista Plat which has stormwater performance standards (e.g. 90% stay-on infiltration volume, peak rate control, water quality, etc.) that need to be met within Lot 15. The designer may contact Fitchburg's Environmental Engineer at 270-4264 or rick.eilertson@fitchburgwi.gov if he/she has any questions on ECSWM performance standards for this site.
 - Applicant Response: This is understood.
- 4. Sheet C200 is missing information on the existing storm sewer pipe under Fitchrona Road. There are also several street terrace infiltration areas proposed along Quarry Vista Drive and Turnstone Lane that are missing. A meeting with Montgomery Associates-Resource Solutions and Rick Eilertson would be recommended to help ensure proper coordination of stormwater facility design and construction.

Applicant Response: This item is being coordinated.